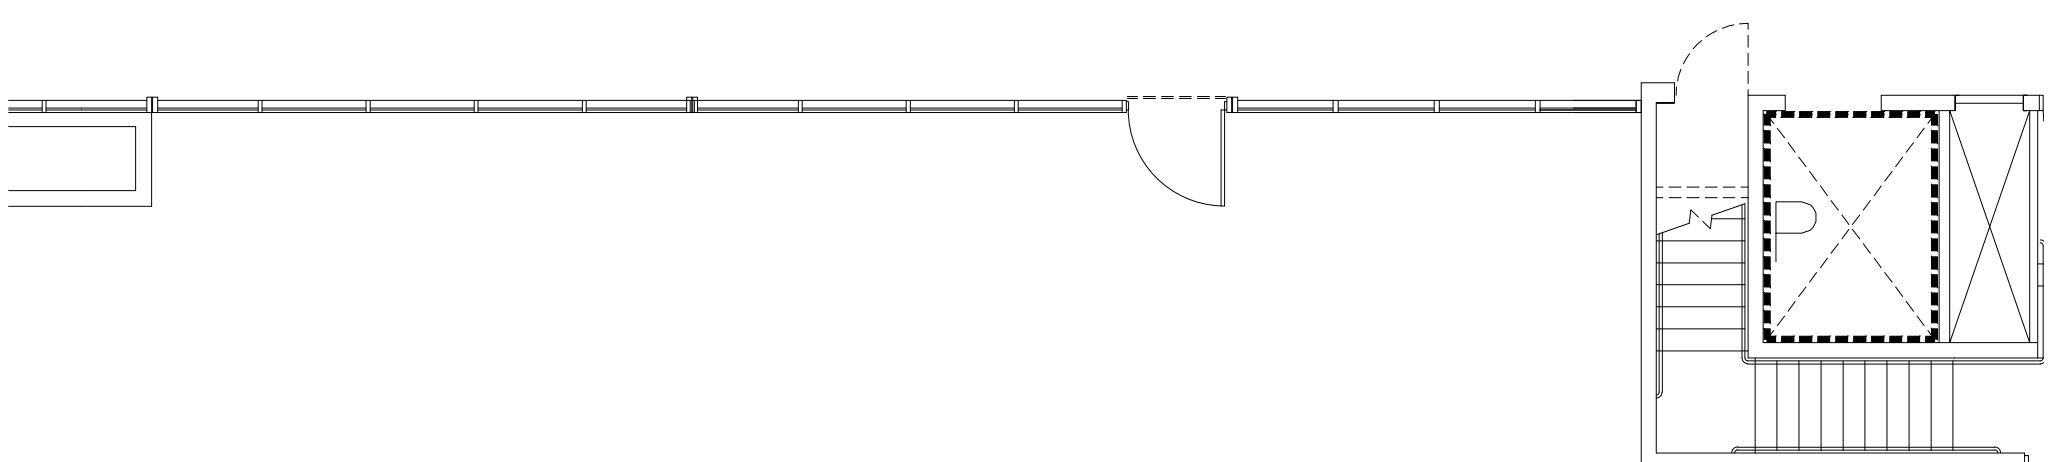
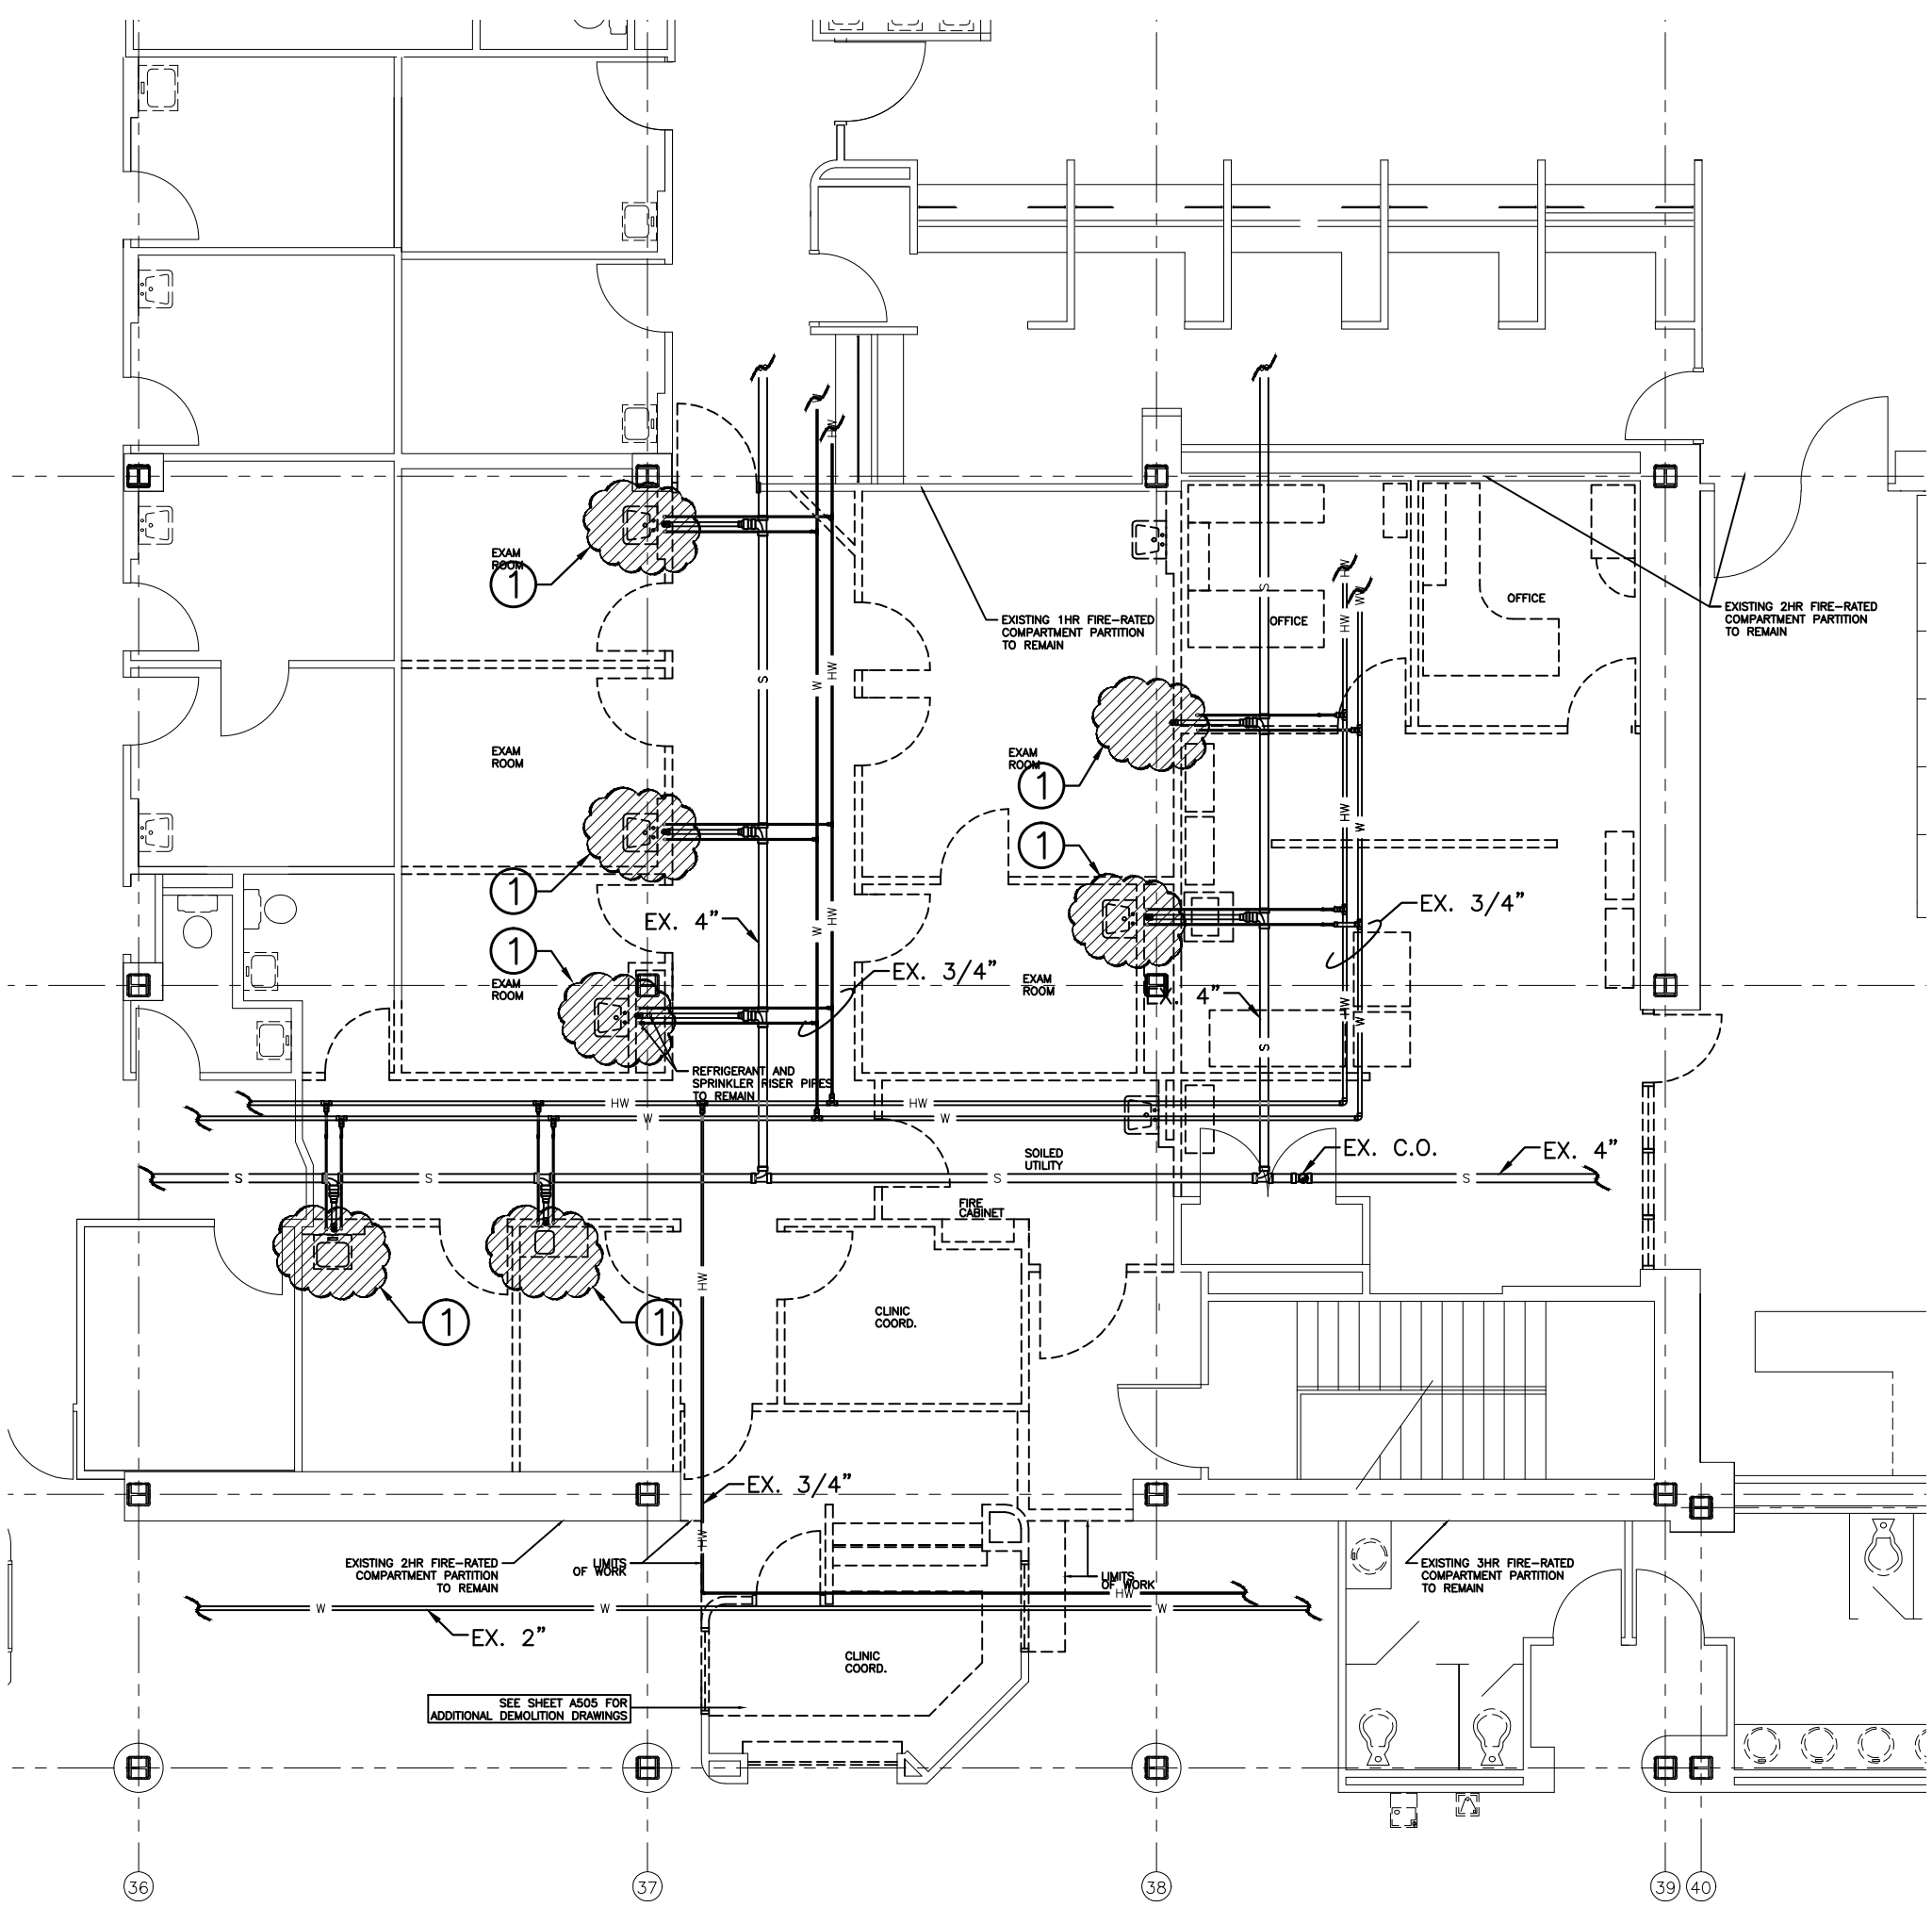
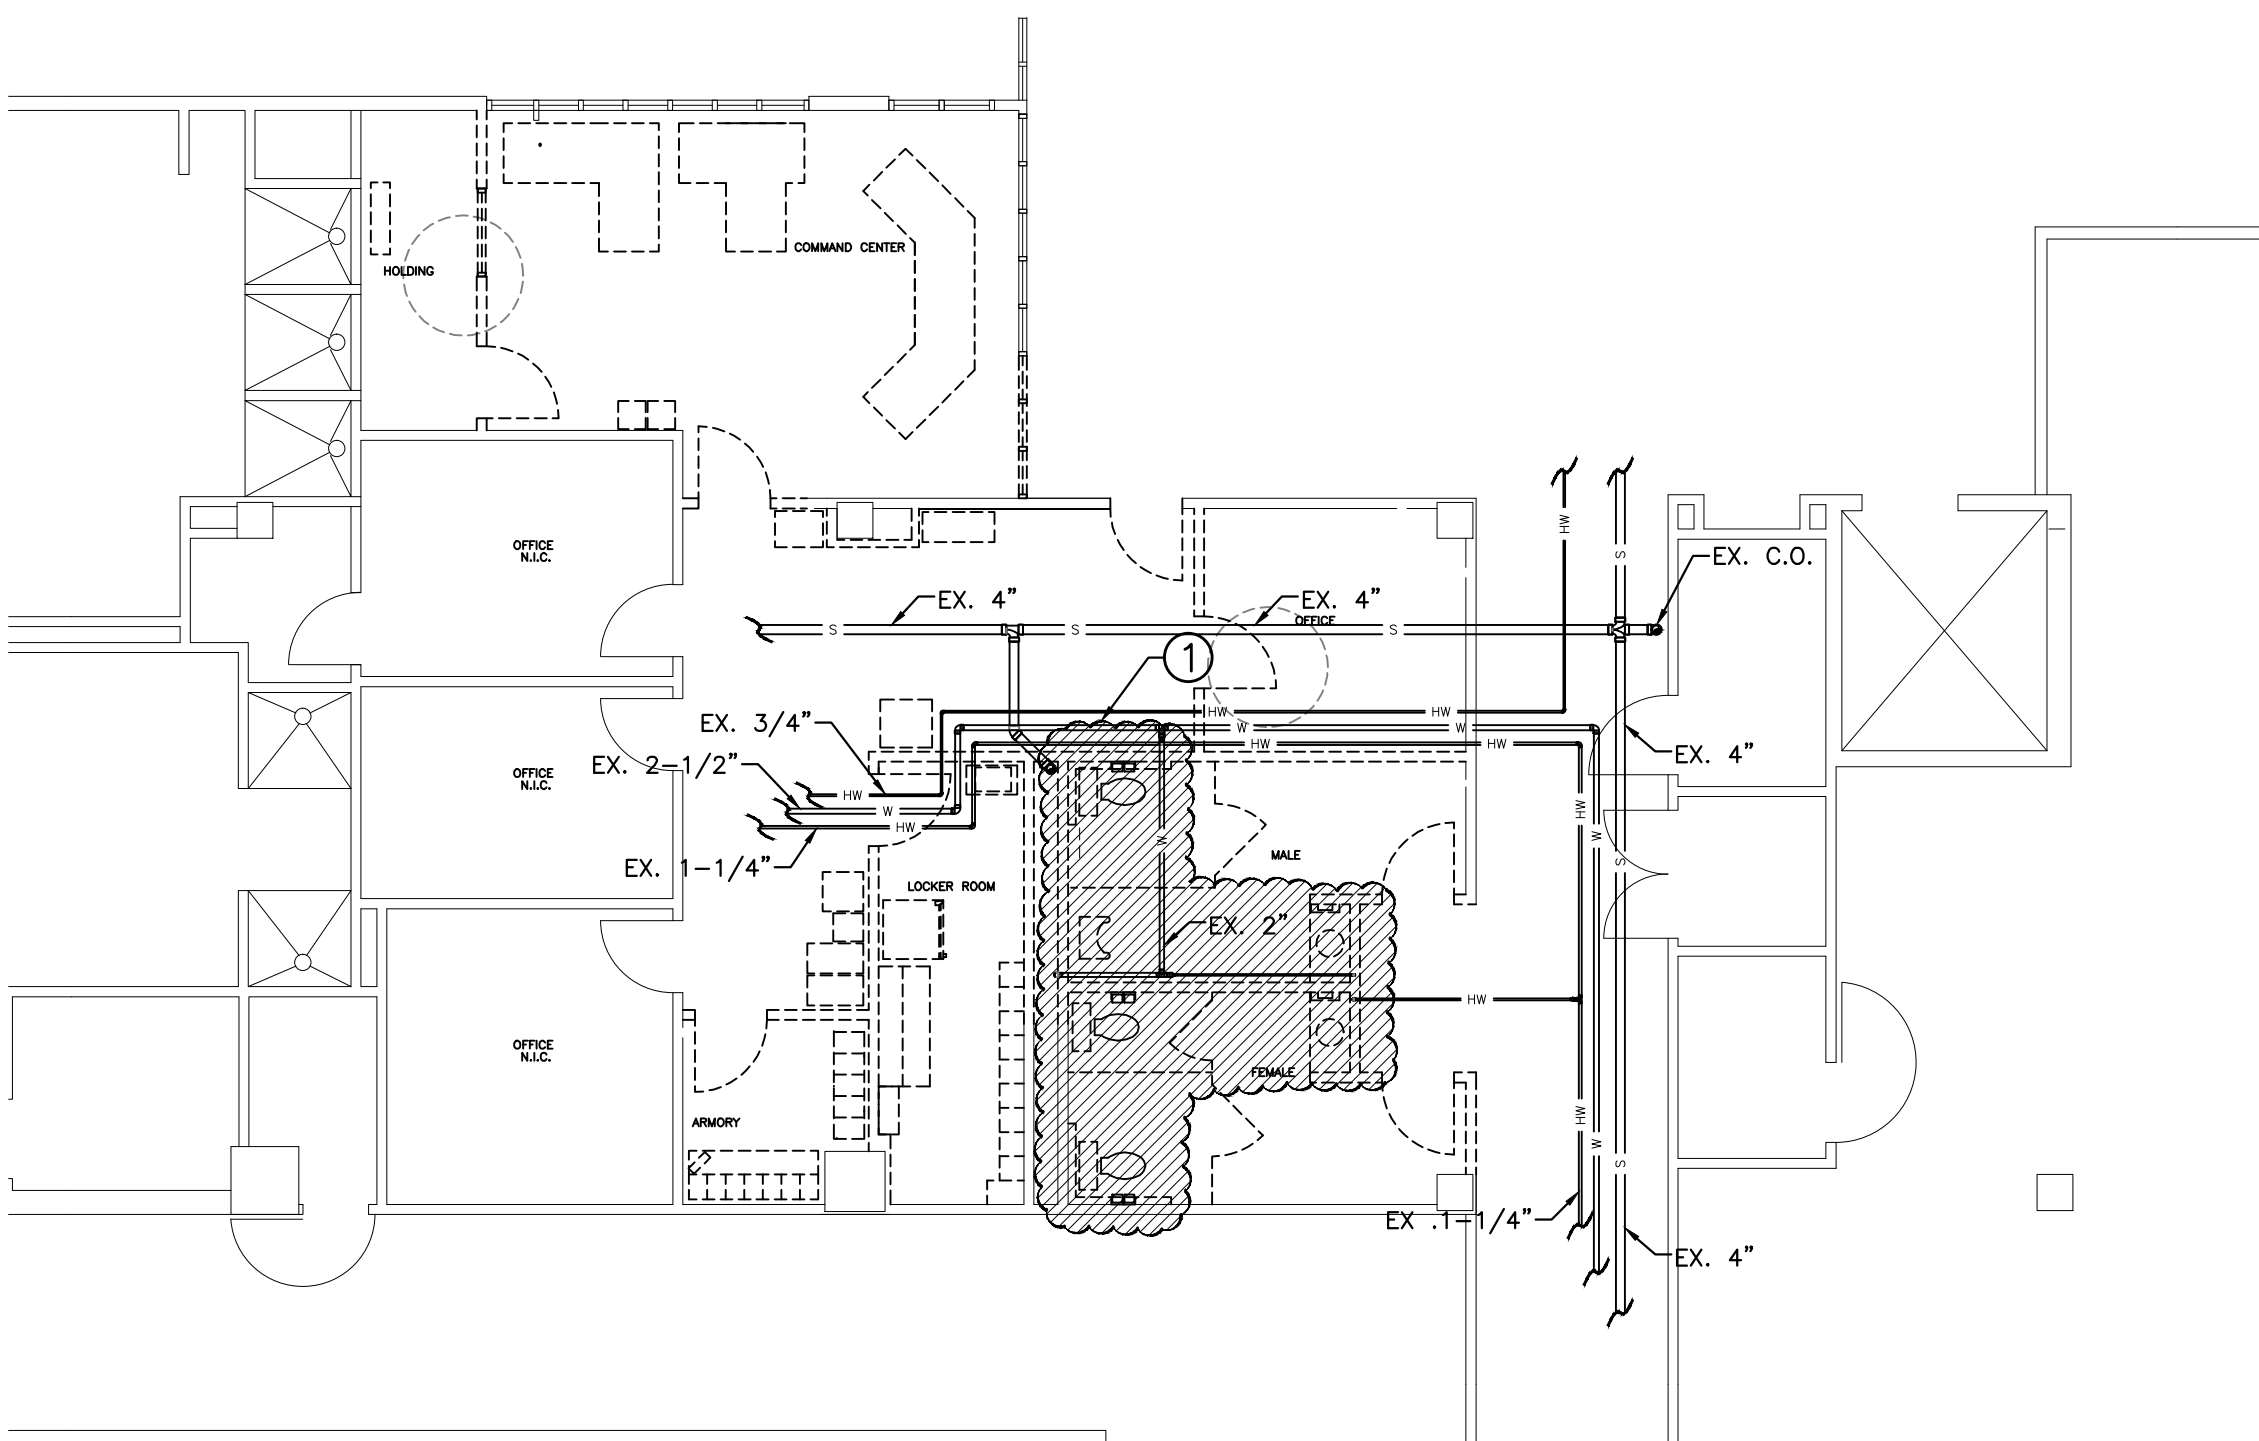


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C one inch = one foot
D three-quarters inch = one foot
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F three-eighths inch = one foot
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H one-eighth inch = one foot



BLDG 801 DOWNTOWN - DEMOLITION PLUMBING PLAN
SCALE: 1/8"=1'-0"



BLDG 110 UPTOWN - DEMOLITION PLUMBING PLAN
SCALE: 1/8"=1'-0"

PLUMBING NOTES

- THESE DRAWINGS ARE SCHEMATIC IN NATURE AND ARE NOT INTENDED TO SHOW ALL POSSIBLE CONDITIONS. IT IS INTENDED THAT A COMPLETE PLUMBING SYSTEM BE PROVIDED WITH ALL NECESSARY EQUIPMENT, ACCESSORIES, AND CONTROLS COMPLETELY COORDINATED WITH ALL TRADES. ALL REQUIREMENTS OWNERS SHALL BE STRICTLY CONFORMED TO. ANY ITEMS AND LABOR REQUIRED FOR A COMPLETE PLUMBING SYSTEM IN ACCORDANCE WITH ALL APPLICABLE CODES, STANDARDS, LOCAL AUTHORITIES, AND THESE CONTRACT DOCUMENTS SHALL BE FURNISHED WITHOUT INCURRING ANY ADDITIONAL COST TO THE OWNER. CAREFULLY REVIEW ALL CONTRACT DOCUMENTS AND THE DESIGN OF OTHER TRADES BEFORE PREPARING SHOP DRAWINGS.
- VERIFY LOCATION OF ALL FIXTURES WITH ARCHITECTURAL PLANS.
- INSTALL BACKFLOW PREVENTION IN ACCORDANCE WITH CITY AND STATE REQUIREMENTS. INSTALL ON MAIN DOMESTIC WATER SERVICE TO THE BUILDING.
- CONTRACTOR SHALL INSTALL WATER HAMMER ARRESTER EQUAL TO ZURN SERIES 1700 AT EACH PLUMBING GROUP.
- CONTRACTOR TO FURNISH AND INSTALL ANTI-SIPHON VALVE ON EACH WATER HEATER.
- CONTRACTOR SHALL FURNISH AND INSTALL BALL VALVES FOR WATER SHUT-OFF AT EACH FIXTURE GROUPING.
- ALL PLUMBING COMPONENTS TO BE LEAD-FREE.
- TRAP PRIMERS TO BE PRECISION PLUMBING PRODUCTS MODEL NO. PQ-500 WITH A6-500 AIR GAPS OR APPROVED EQUAL. DISTRIBUTION CUP (DU-4) ABOVE CEILING OR BEHIND ACCESS PANEL FOR UP TO FOUR FLOOR DRAINS.
- INSULATE ALL HANDICAP LAVATORIES WITH TRIBURO MODEL NO. 102W AND TWO(2) MODEL NO. 105W HANDI LAV-GUARD.
- COORDINATE ALL WORK WITH ARCHITECTURAL, STRUCTURAL, HVAC AND ELECTRICAL TRADES. PIPE ROUTING SHOWN IS DIAGRAMMATIC. PROVIDE ALL OFFSETS, ETC., TO AVOID INTERFERENCES WITH EQUIPMENT, PIPING, DUCTWORK, LIGHTS, CONDUIT, ETC..
- COORDINATE ALL FLOOR PENETRATIONS WITH STRUCTURAL DRAWINGS. SET SLEEVES IN FLOORS AND WALLS AND ATTACHMENTS FOR HANGERS AS CONSTRUCTION PROGRESSES. ALL PENETRATIONS MUST BE SEALED AND HELD AS TIGHT TO COLUMNS OR WALLS AS POSSIBLE.
- PROVIDE 12" X 12" ACCESS PANEL FOR SHOCK ABSORBERS, TRAP PRIMERS AND ALL VALVES LOCATED ABOVE NON-ACCESSIBLE CEILINGS AND INSIDE PIPE CHASES. EXACT LOCATION MUST BE COORDINATED WITH ARCHITECTURAL AND APPROVED BY ARCHITECT PRIOR TO INSTALLATION.
- ALL PIPING SHALL BE CONCEALED INSIDE WALLS AND IN PIPE CHASES OR ABOVE CEILINGS. HOLD ALL PIPING ABOVE CEILING AS HIGH AS POSSIBLE.
- HORIZONTAL DRAINAGE PIPING OF 2-1/2" INCH DIAMETER OR LESS SHALL BE INSTALLED WITH A FALL OF NOT LESS THAN 1/4" INCH PER FOOT. PIPING 3" AND LARGER SHALL BE INSTALLED WITH A FALL OF NOT LESS THAN 1/8" INCH PER FOOT.
- CONTRACTOR SHALL MAKE FINAL CONNECTIONS TO ALL DOMESTIC WATER AND SANITARY SEWERS, UNLESS OTHERWISE NOTED.
- COORDINATE ALL UNDERGROUND PIPING WITH GRADE BEAMS, WALL FOOTINGS AND OTHER STRUCTURAL CONDITIONS.
- PLUMBING CONTRACTOR SHALL MAKE FINAL CONNECTIONS TO ALL EQUIPMENT INDICATED ON DRAWINGS. FINAL CONNECTION SHALL INCLUDE ANY ADAPTORS, NIPPLES, SHUT-OFF VALVES, PRV'S, SHOCK ABSORBERS, BACKFLOW PREVENTION DEVICES, REGULATORS ETC..
- ALL STRUCTURAL PENETRATIONS (SLEEVES, BLOCKOUTS, ETC.) ARE TO BE LOCATED AND COORDINATED IN THE FIELD BY THE CONTRACTOR IN RELATION TO THE REQUIREMENTS OF FINAL EQUIPMENT AND FIXTURES SELECTED.
- SET FLOOR DRAIN ELEVATION DEPRESSED BELOW FINISHED SLAB ELEVATION AS LISTED BELOW TO PROVIDE PROPER FLOOR SLOPE TO DRAIN:
5 FOOT DRAIN RADIUS : 1/2" DEPRESSION
10 FOOT DRAIN RADIUS : 3/4" DEPRESSION
15 FOOT DRAIN RADIUS : 1" DEPRESSION
20 FOOT DRAIN RADIUS : 1-1/4" DEPRESSION
25 FOOT DRAIN RADIUS : 1-1/2" DEPRESSION
- ALL TRAP ARMS, P-TRAPS, ETC. EXPOSED UNDER LAVATORIES SHALL BE 18 GA. CHROME PLATED.
- ALL STOPS/SUPPLIES SHALL BE CHROME PLATED BRASS.
- PROVIDE WATER PRESSURE REDUCING/REGULATING VALVE ON MAIN SERVICE WHEN MAIN PRESSURE EXCEEDS 75 PSI AT ANY TIME OF DAY. COORDINATE WITH LOCAL UTILITY.
- FIELD VERIFY EXACT SIZE, MATERIAL, AND LOCATION OF ALL EXISTING UTILITIES BEFORE BEGINNING WORK.
- PROVIDE REDUCED PRESSURE BACKFLOW PREVENTER AT ALL CONNECTIONS TO MECHANICAL EQUIPMENT, KITCHEN AND LAUNDRY EQUIPMENT, ETC. AS REQUIRED BY CODE AND BY LOCAL AUTHORITY. CONTRACTOR IS TO VERIFY WITH THE LOCAL AUTHORITY THE TYPE OF BACKFLOW PREVENTION DEVICE REQUIRED FOR ALL APPLICATIONS PRIOR TO INSTALLATION.
- ALL DRAIN PIPING LOCATED WITHIN RETURN AIR PLENUM SHALL BE TREATED AS DOMESTIC WATER PIPING. THIS INCLUDES PIPING AND INSULATION. ALL CONDENSATE DRAIN PIPING THAT IS NOT LOCATED WITHIN RETURN AIR PLENUM MAY BE SCHEDULE 40 PVC WITH 1/2" ARMAFLEX INSULATION.
- ALL OVERHEAD WATER PIPING SHALL BE INSTALLED BELOW CEILING INSULATION.
- VERIFY ALL FIXTURE MOUNTING HEIGHTS WITH ENGINEER AND ARCHITECT.
- VERIFY ORIENTATION OF FLUSHING MECHANISM ON TOILET/URNAL WITH ARCHITECT/ENGINEER PRIOR TO ROUGH-IN.
- ABOVE GROUND DRAINAGE AND VENT PIPING LOCATED WITHIN FIRE RATED WALLS SHALL BE COPPER PIPE IN ACCORDANCE WITH STANDARDS ASTM B42 AND B302 OR CAST IRON PIPE IN ACCORDANCE WITH STANDARDS ASTM A 74; ASTM A 888; CSFR 301.
- COORDINATE ALL FLOOR SINK GRATE ORIENTATIONS AND REQUIRED OPEN SPACES (1/2 GRATE, 3/4 GRATE, ETC.) WITH KITCHEN EQUIPMENT CONSULTANT.
- PROVIDE INSULATING UNION BETWEEN ABOVE AND BELOW GROUND GAS PIPING.
- ALL EXPOSED INTERIOR OR EXTERIOR GAS LINES ARE TO BE PAINTED BY THE PLUMBING CONTRACTOR WITH ONE COAT OF LATEX PAINT. INTERIOR COLOR TO MATCH WALL. EXTERIOR COLOR TO BE SELECTED BY ARCHITECT.
- LABEL ALL 2PSIG GAS PIPING IN ACCORDANCE WITH 2009 INTERNATIONAL CODES (6 FT. CENTERS).
- INSTALL ANGLE COVER OVER CONDENSATE LINES, SPRINKLER LINES, ETC. THAT CROSS MEZZANINE FLOOR WHERE TRIPPING MIGHT BE A HAZARD. PRIME AND PAINT ANGLE COVER SAFETY YELLOW COLOR.
- PRIME AND PAINT ALL EXPOSED GAS PIPING. VERIFY COLOR WITH ENGINEER.
- FURNISH AND INSTALL GAS PRESSURE REGULATING/REDUCING VALVES AT EACH APPLIANCE. WHERE REGULATORS ARE SELF-LIMITING TYPE, VENTS SHALL BE EXTENDED TO THE BUILDING EXTERIOR.
- ALL GAS PIPING SHALL BE FURNISHED AND INSTALLED IN ACCORDANCE WITH NFPA 54, INTERNATIONAL FUEL GAS CODE.
- UNDERGROUND GAS PIPING TO BE ASTM D 2513, POLYETHYLENE, DR 11 OR DR 11.5 MEDIUM PRESSURE.

PLUMBING DEMOLITION NOTES

- REMOVE EXISTING PLUMBING FIXTURE(S). CAP ANY WASTE, WATER AND VENT PIPING IN WALLS, FLOORS OR ABOVE CEILING THAT IS NOT BEING USED FOR REVISED LAYOUT. PATCH AND REPAIR ALL SURFACES TO MATCH EXISTING/NEW FINISHES.
- GENERAL:
VERIFY DISPOSITION OF ALL EQUIPMENT WITH OWNER. INCLUDE ALL COSTS ASSOCIATED WITH COMPLETE REMOVAL AND DISPOSAL IN ACCORDANCE WITH CITY, STATE AND FEDERAL REGULATIONS.
REPAIR/REPLACE ANY EXISTING EQUIPMENT DAMAGED DURING DEMOLITION.
PATCH/REPAIR ANY EXISTING CEILING, ETC. TO MATCH EXISTING/NEW FINISHES.
CONTRACTOR SHALL REVIEW ALL EXISTING CONDITIONS PRIOR TO STARTING WORK.

PLUMBING EQUIPMENT SCHEDULE

MARK NO.	FIXTURE TYPE	MANUFACTURER'S MODEL NO.	MOUNT	MOUNT HEIGHT	WASTE SIZE	VENT SIZE	C.W. SIZE	H.W. SIZE	NOTES
WC-1A	WATER CLOSET FLUSH VALVE ADA	ZURN MODEL NO. Z5610 OR APPROVED EQUAL	WALL	16-1/8" TO RIM	4"	2"	1 1/4"	-	WHITE ELONGATED VITREOUS CHINA. FLUSH VALVE WALL SUPPORT. WHITE OPEN FRONT SOLID PLASTIC SEAT. BOLT CAPS 1/2" ROUNDOFF-IN. ZURN ZER6000AV-CPM AUTOMATIC FLUSHOMETER WITH MANUAL OVERRIDE. WALL BOWL CONCEALED CARRIER SYSTEM
L-1A	LAVATORY, ADA 20"x18"	ZURN MODEL NO. Z5344 OR APPROVED EQUAL	WALL	34" TO LIP	1-1/4"	1-1/4"	1/2"	1/2"	WHITE VITREOUS CHINA. OPEN GRID STRAINER. DELTA MODEL NO. 501-DST FAUCET, W/ 0.5 GPM AERATOR. P-TRAP W/ CLEANOUT. CONCEALED ARM CARRIER, SUPPLIES W/ STOPS
S-1	UNDERMOUNT SINGLE BOWL SINK	ELKAY MODEL NO. ELU2118 OR APPROVED EQUAL	UNDERMOUNT	-	1-1/2"	1-1/4"	1/2"	1/2"	ELKAY LK-335 STRAINER, DELTA MODEL NO. 1501T3370 SENSOR FAUCET, SUPPLIES WITH STOPS. P-TRAP WITH CLEANOUT. ELKAY LKWB062118SS BOTTOM GRID, ELKAY LKCUCLIP8 MOUNTING CLIPS

EQUALS BY ELJER, KOHLER, TOTO, AND AMERICAN STANDARD WILL BE ACCEPTED.

PLUMBING SPECIALITY SCHEDULE

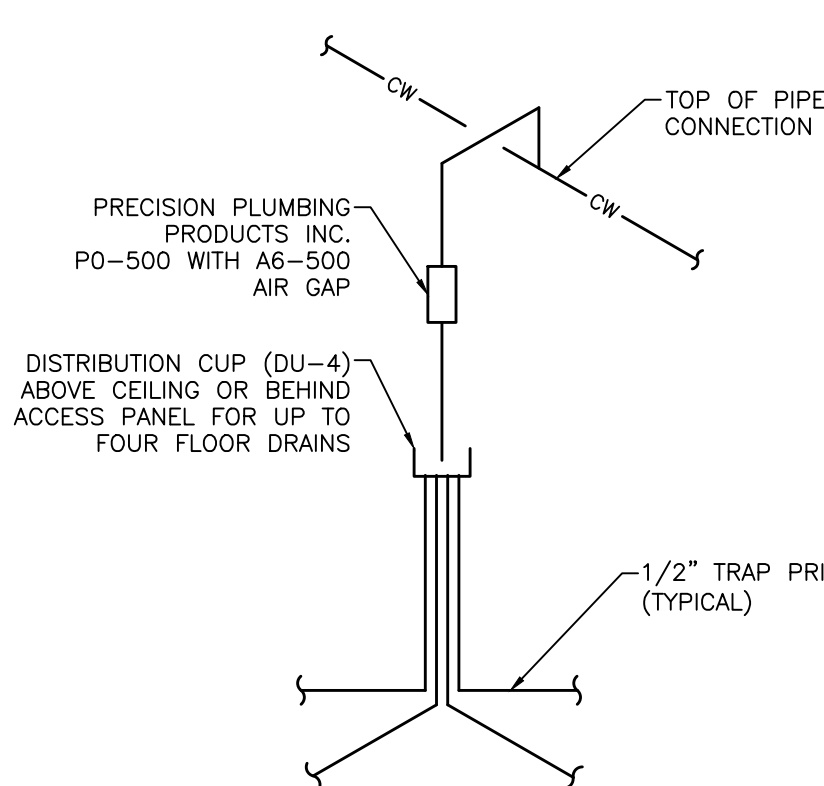
MARK NO.	FIXTURE TYPE	MANUFACTURER'S MODEL NO.	MOUNT	MOUNT HEIGHT	WASTE SIZE	VENT SIZE	C.W. SIZE	H.W. SIZE	MIXED WATER SIZE	NOTES
FD-1	FLOOR DRAIN	ZURN MODEL NO. ZN-415-P OR APPROVED EQUAL	FLOOR	-	4"	2"	1/2"	-	-	5" DIA. NICKEL BRONZE ADJUSTABLE TOP 1/2" TRAP PRIMER W/ PROSET SYSTEM INC. TG34IP RETROFIT TRAP GUARD
W.H.A.	WATER HAMMER ARRESTOR	ZURN SERIES 1700 OR APPROVED EQUAL	-	-	-	-	VARIES	VARIES	-	
WB-1	ICEMAKER WALLBOX	OATEY MODEL NO. 38574 OR APPROVED EQUAL	WALL	36" A.F.F.	-	-	1/2"	-	-	1/4 TURN BRASS BALL VALVE - COPPER SWEAT - STANDARD PACK WITH 6" STAINLESS STEEL HOSE

EQUALS BY SMITH OR JONES WILL BE ACCEPTED

PLUMBING LEGEND

SS	SOIL OR SANITARY SEWER	CW	COLD WATER
SD	STORM DRAIN, RAINWATER DRAIN	HW	110° HOT WATER
CD	CONDENSATE DRAIN	HW	140° HOT WATER
V	VENT	HW	HOT WATER RETURN
NG	NATURAL GAS	TP	TRAP PRIMER
RD	RISER DOWN (ELBOW)	FD	FLOOR DRAIN
RU	RISER UP (ELBOW)	FS	FLOOR SINK
90	90° ELBOW	HD	HUB DRAIN
TEE	TEE	WH	WALL HYDRANT
CROSS	CROSS	VTR	VENT THRU ROOF
CONNECT TO EXISTING	CONNECT TO EXISTING	SV	SHUT-OFF BALL VALVE
RT	RUNNING TRAP	GV	GATE VALVE
AAV	AIR ADMITTANCE VALVE (SBCCI APPROVED)	BFV	BUTTERFLY VALVE
U	UNION	3WV	THREE WAY VALVE
SI	SIAMESE FIRE DEPARTMENT CONNECTION	GC	GAS COCK
SP	SPRINKLER HEAD	CV	CHECK VALVE
S	EXISTING SANITARY SEWER	LP	LIQUID PROPANE
W	EXISTING WATER	CW	GREASE WASTE
HW	EXISTING HOT WATER	GO	GREASE/OIL
G	EXISTING GAS	SP	SUMP PUMP DISCHARGE

TYPICAL TRAP PRIMER



MIXING VALVE SCHEDULE

MARK NO.	MANUFACTURER'S MODEL NO.	TEMPERATURE (°F)	INLET	OUTLET
MV-1	POWERS SERIES LM495 LOCATED BELOW LAVATORY	SET AT 90°-110°	1/2"	1/2"
MV-2	POWERS SERIES LM496 ABOVE CEILING THERMOSTATIC MIXING VALVE	SET AT 90°-110°	3/4"	3/4"

MIXING VALVES SHALL CONFORM TO ASSE 1070 AND ASSE 1016

PLUMBING DRAWING INDEX

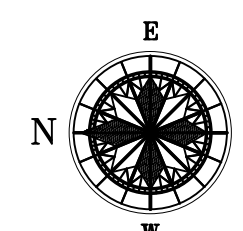
SHEET NO.	SHEET TITLE
P-101	PLUMBING SCHEDULES, LEGEND, NOTES AND DEMOLITION PLANS
P-102	WASTE PLUMBING PLANS
P-103	WATER PLUMBING PLANS

PLUMBING SCHEDULES, NOTES, LEGEND AND DEMOLITION PLANS

RELEASED FOR CONSTRUCTION
100% SPRINKLERED

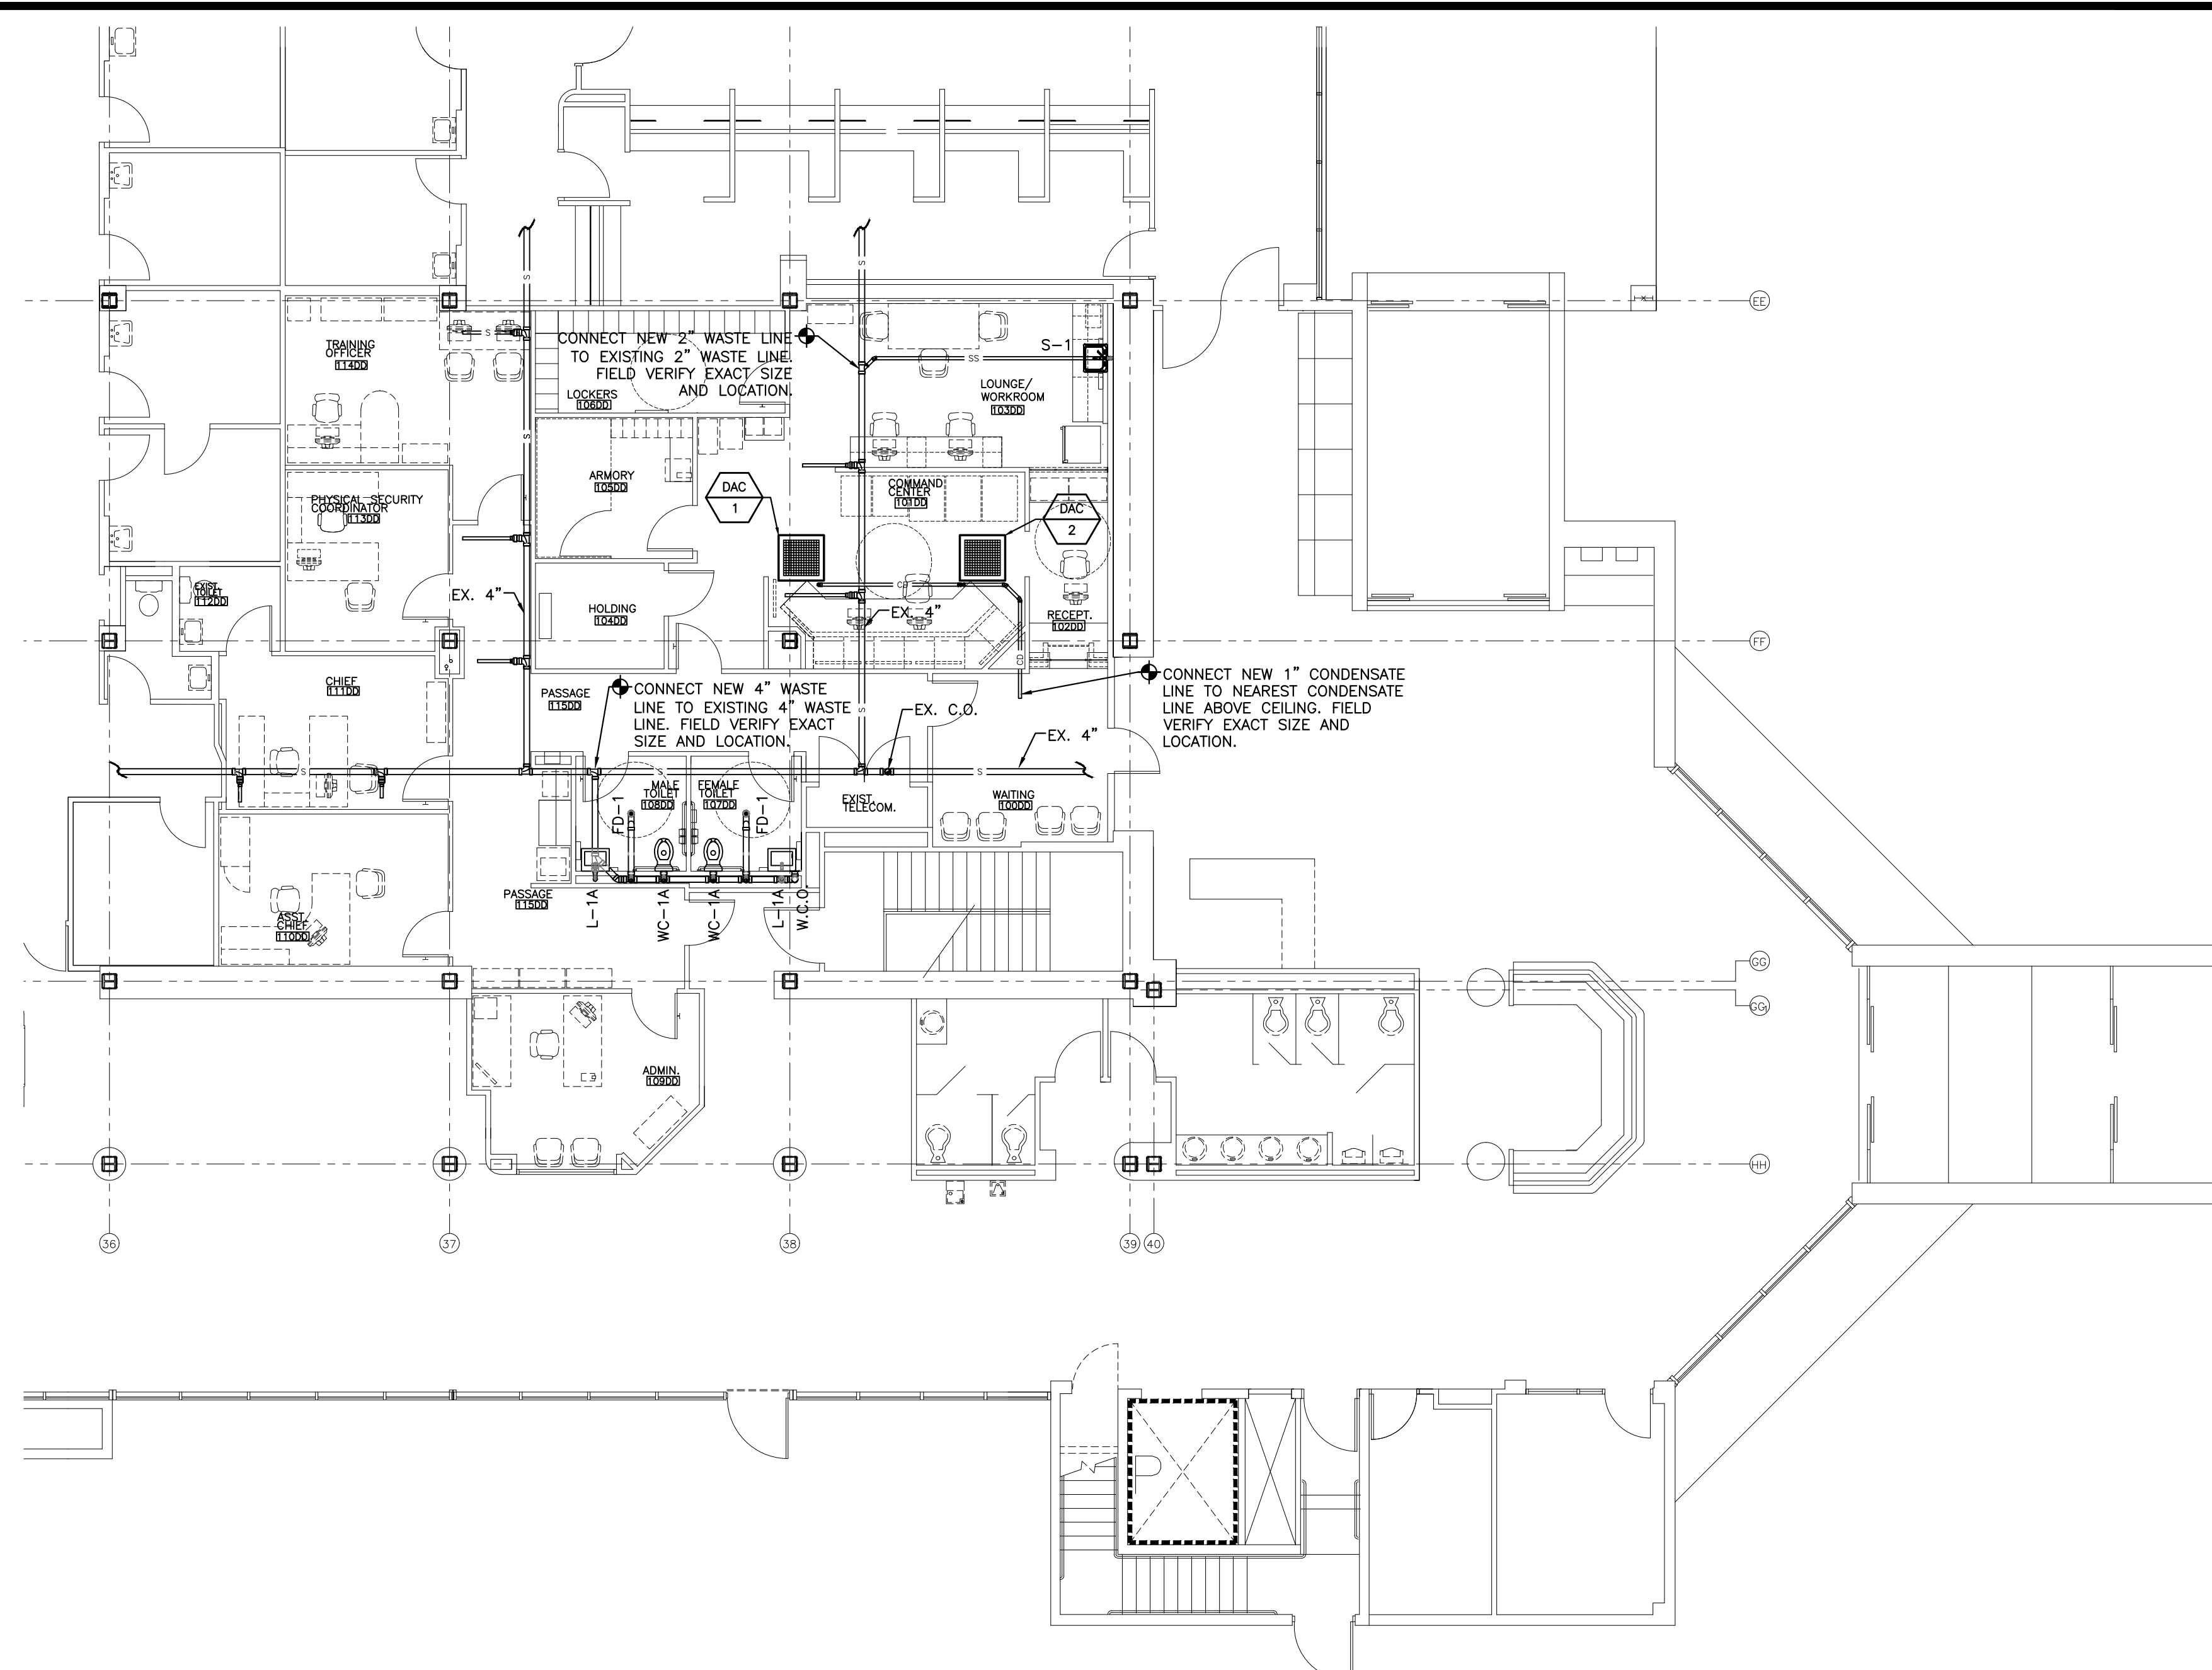
Revisions		Date		ENGINEERS:		Professional Stamp/Seal		ARCHITECT:		Department of Veterans Affairs		Drawing Title		SECURITY ENHANCEMENTS		Augusta VAMC, Augusta, GA		Date		01-23-2013		FINAL		Project No.		509-12-106		Office of Facilities Management		Department of Veterans Affairs	
				MCE		MILLS-CONOLY ENGINEERING, P.C.		WHORTON ENGINEERING, INC.		Wesseldyk + Associates		Architecture Planning Consulting		BLDG 110 UPTOWN (UD)		BLDG 801 DOWNTOWN (DD)		Augusta, GA		DRAWING NO.		P-101		Dwg. 49 of 143							
				8218 Old Federal Road Montgomery, AL 36117 TELEPHONE: (334) 270-0010 FAX: (334) 270-0040		25 SUMMERALL GATE ROAD ANNISTON, ALABAMA 36805 PH 256/820-9897 FAX 256/820-9896				1465 Northside Drive N.W. Suite 215 Atlanta, GA 30318 ph: 404-855-7923																					

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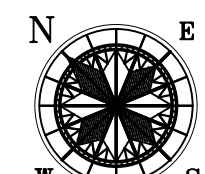
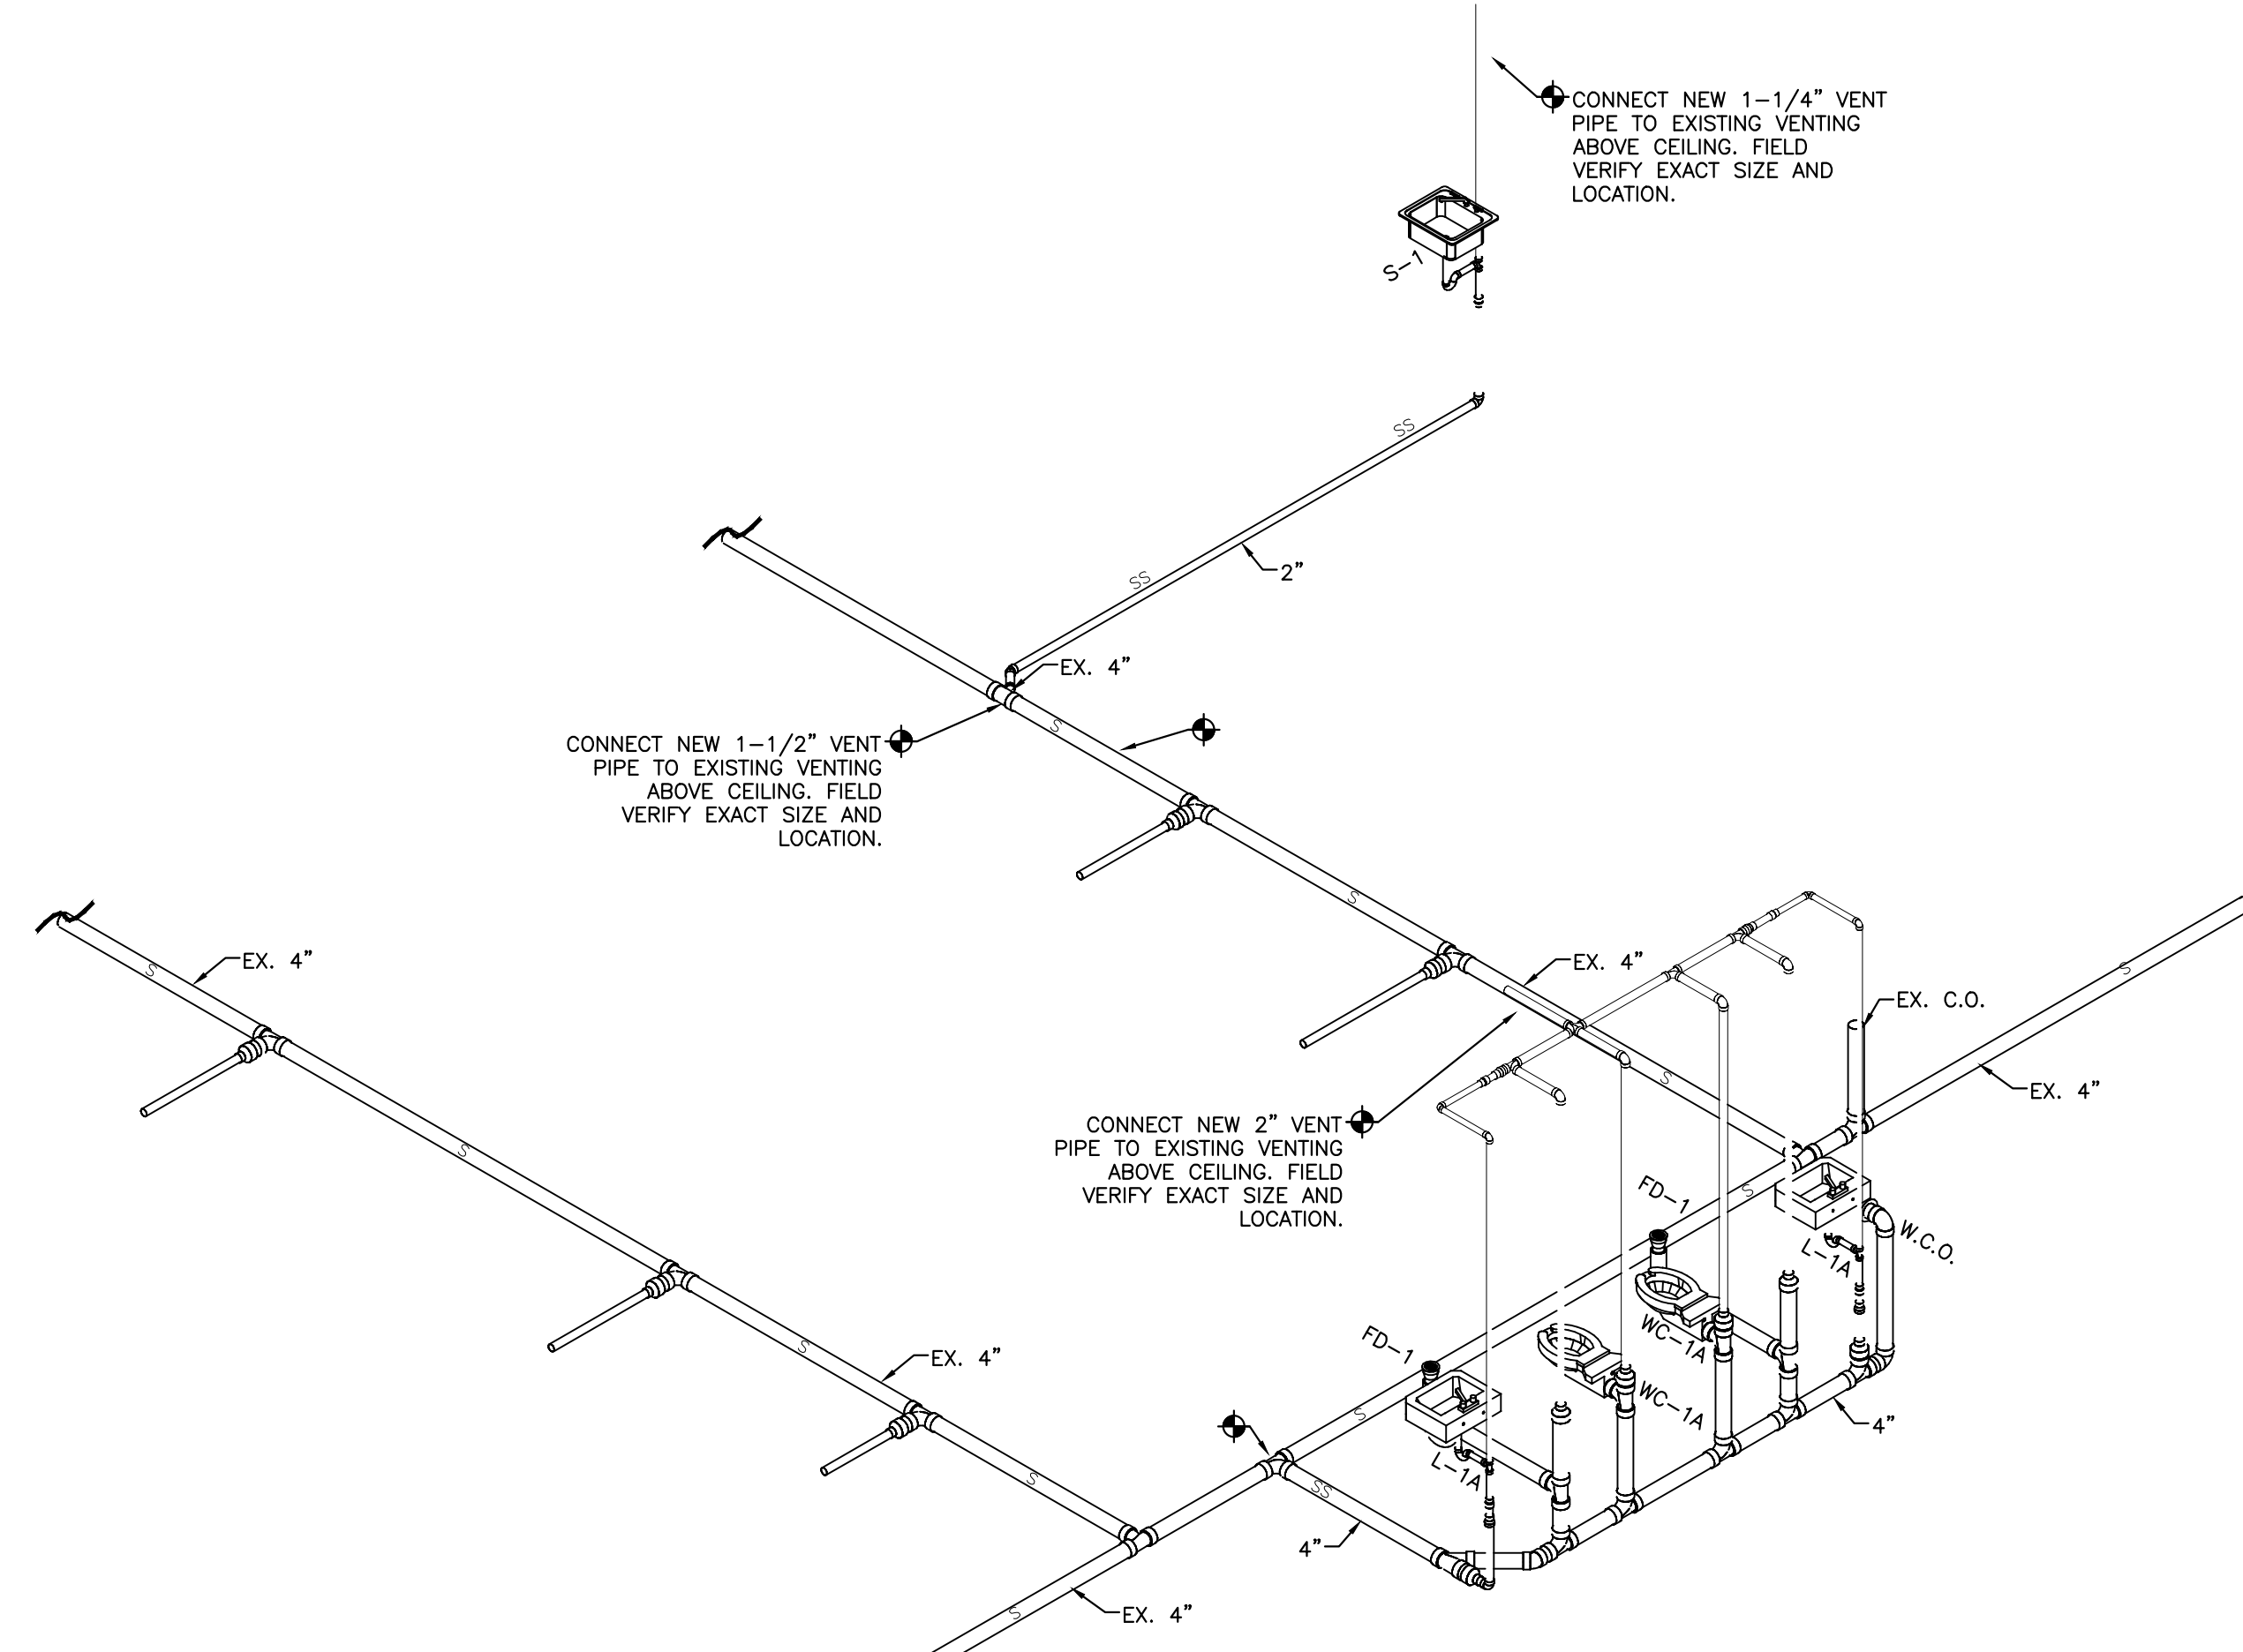
BLDG 801 DOWNTOWN - WASTE PLUMBING PLAN

SCALE: 1/8"=1'-0"



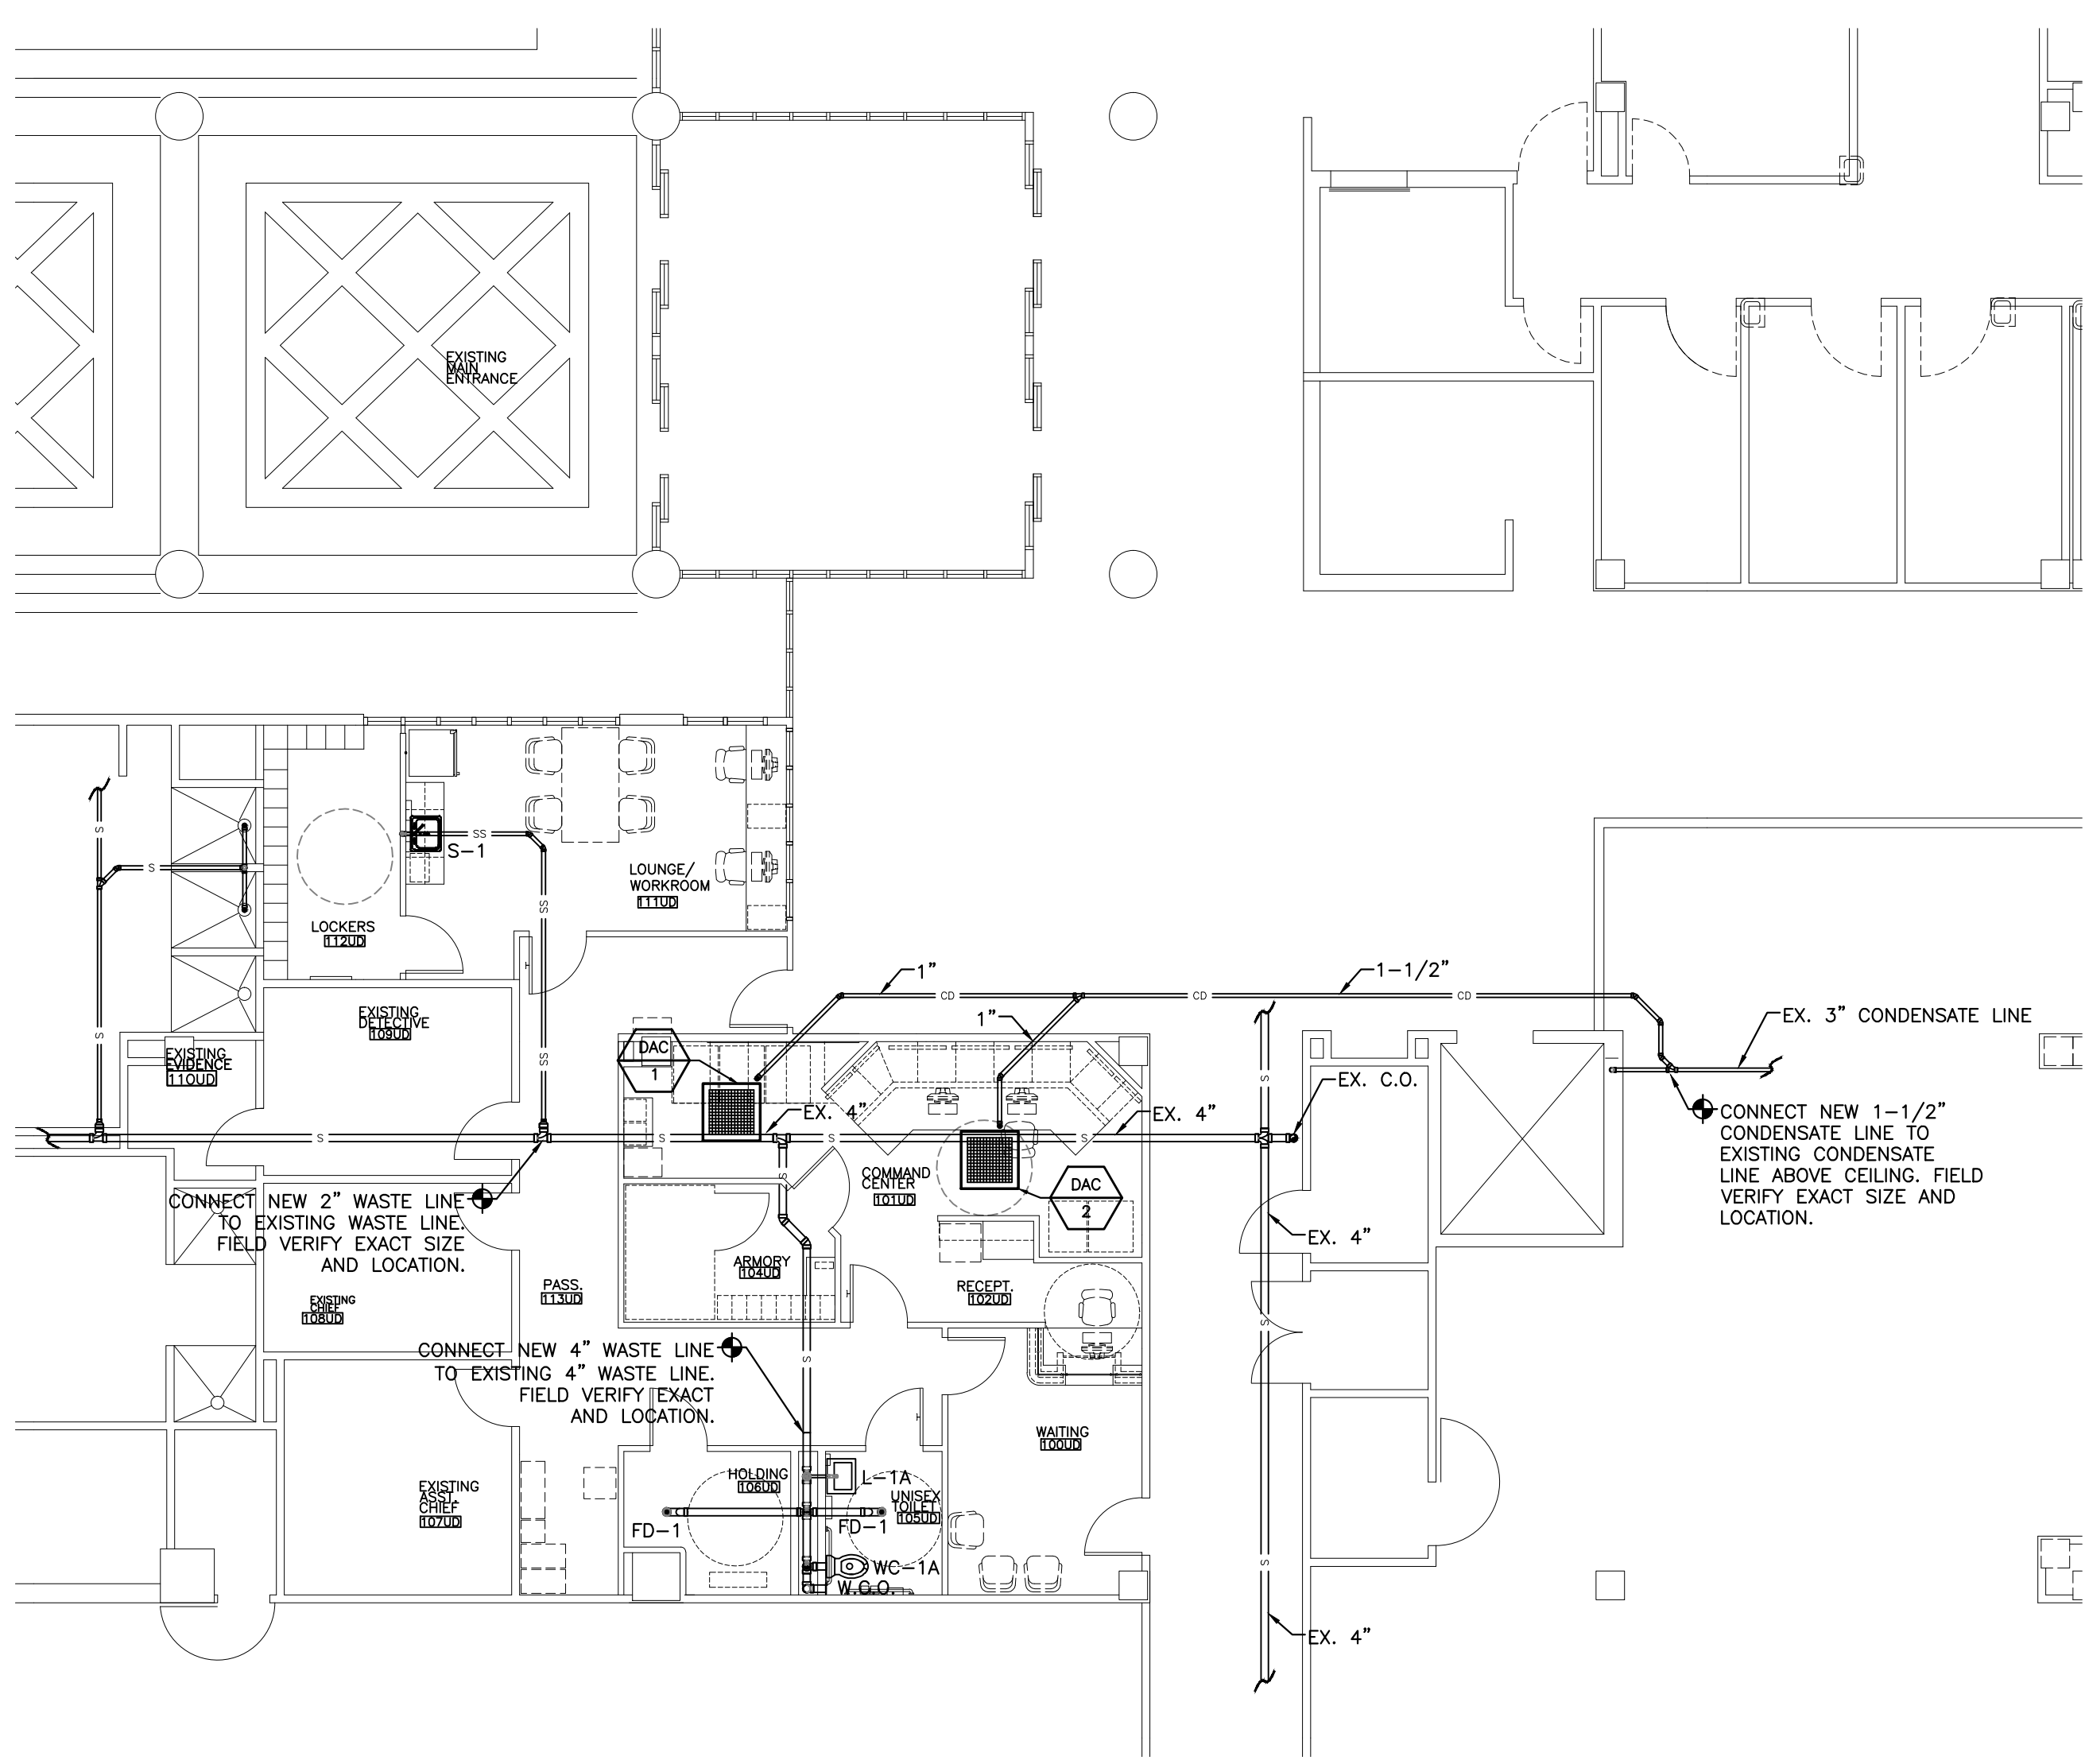
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NOT TO SCALE



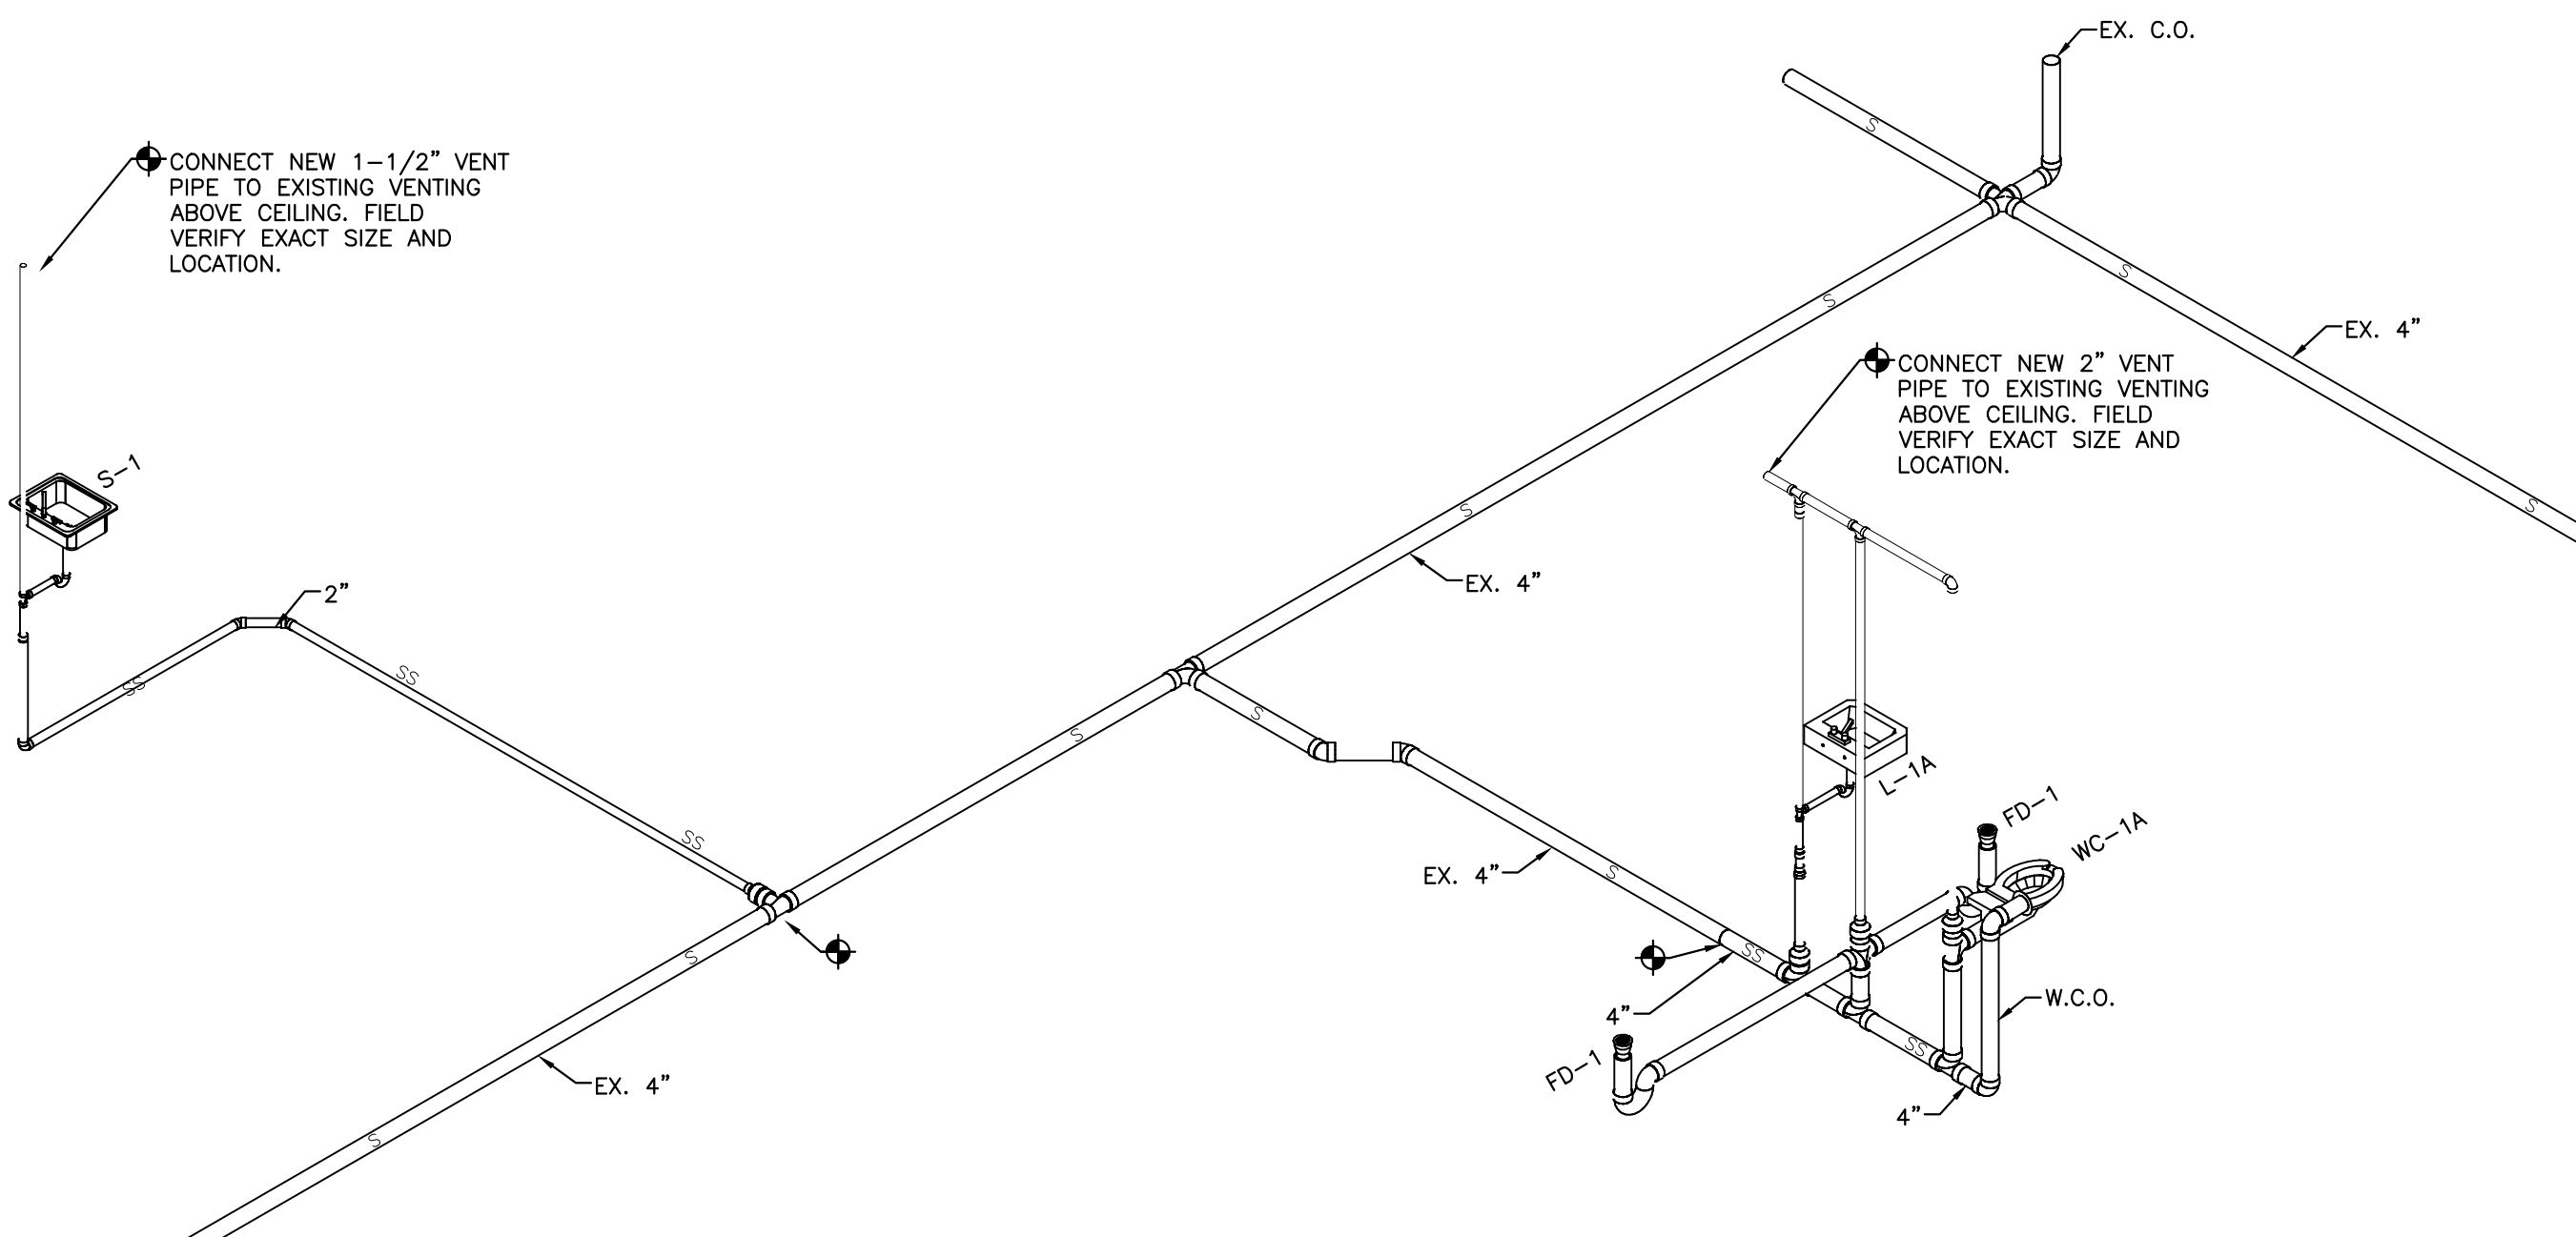
BLDG 110 UPTOWN - WASTE PLUMBING PLAN

SCALE: 1/8"=1'-0"



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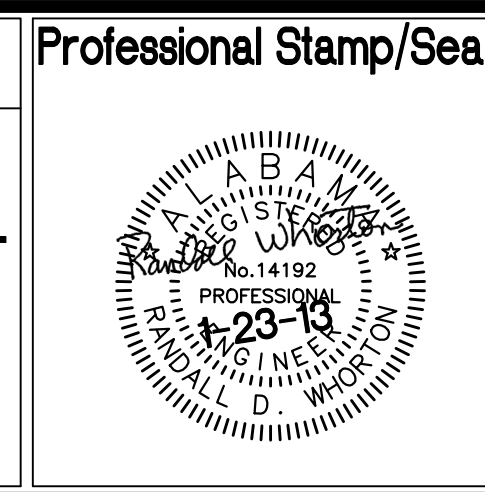


WASTE PLUMBING PLANS

Revisions	Date

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HVAC - PLUMBING - PROCESS CONTROL
25 SUMMERALL GATE ROAD
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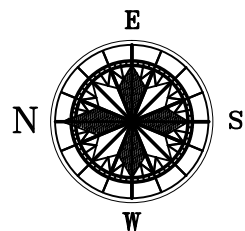
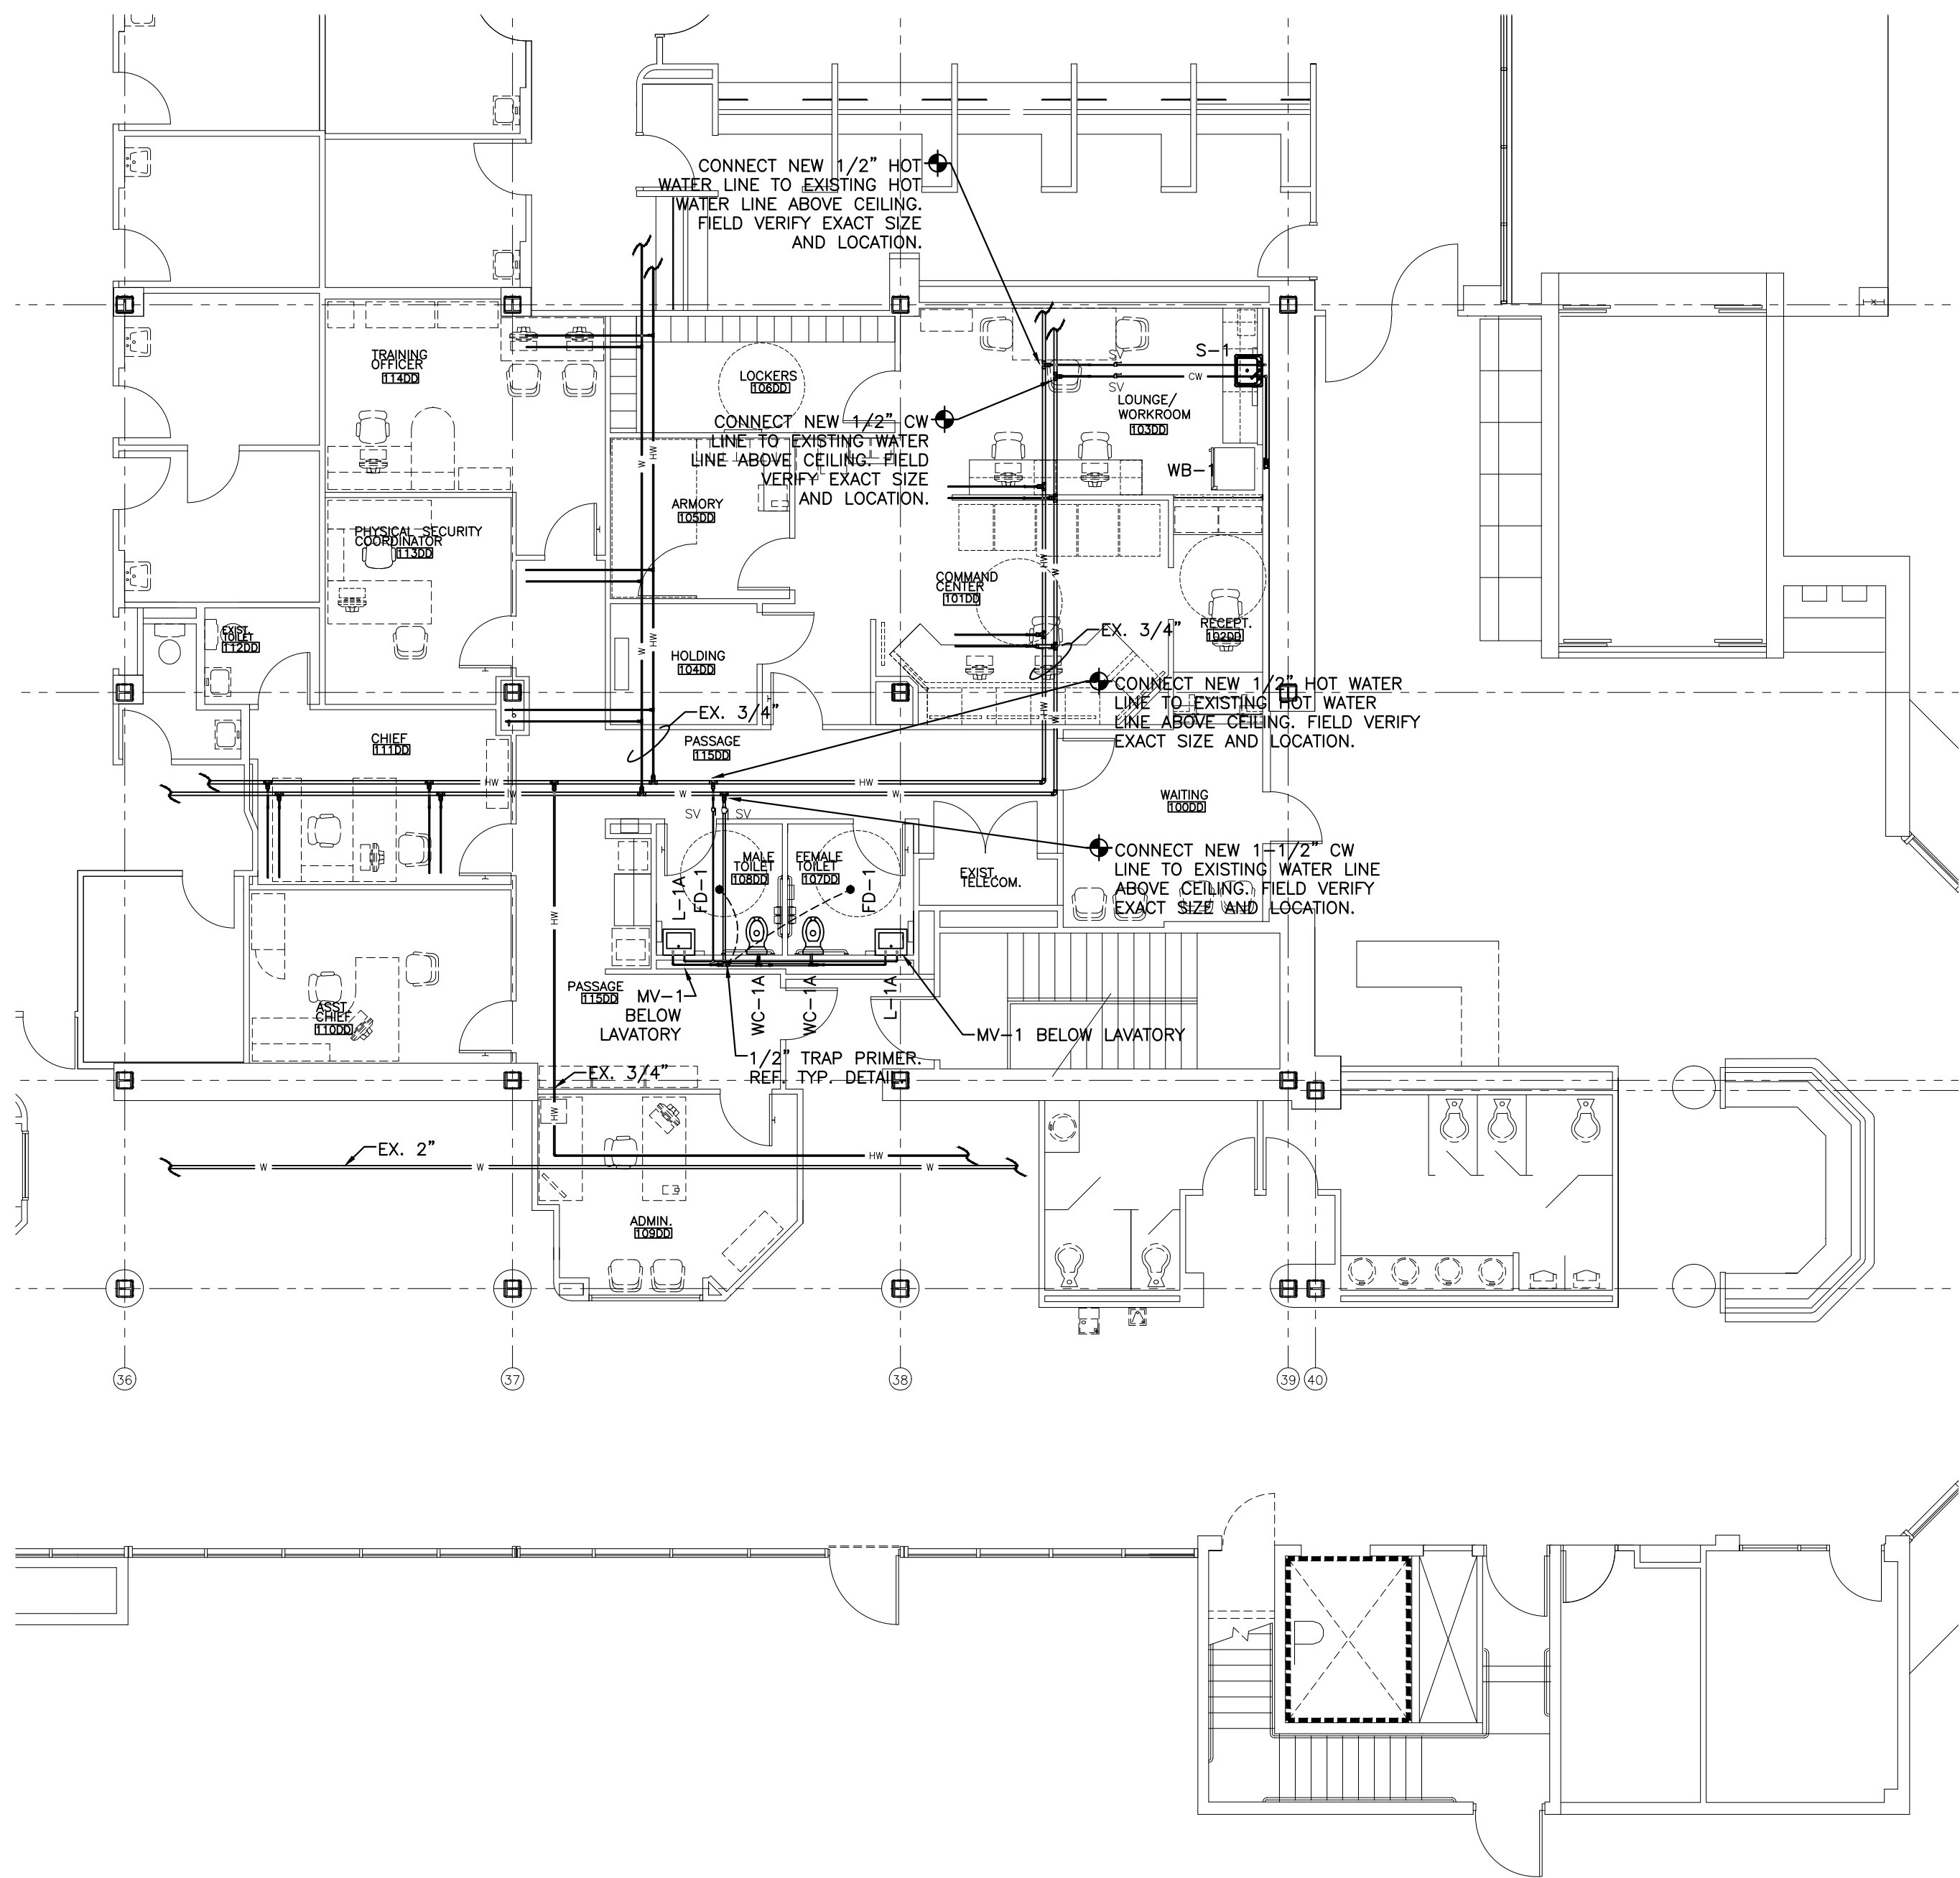
ARCHITECT:
Wesseldyk + Associates
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Drawing Title WASTE PLUMBING PLANS		SECURITY ENHANCEMENTS AUGUSTA VAMC, AUGUSTA, GA		Date 01-23-2013 FINAL	Office of Facilities Management
Approved	Approved	Building No. BLDGS 110 +801	Scale 1/8" = 1'-0"	Project No. 509-12-106	
Approved	Approved	Location BLDG 110 UPTOWN (UD) BLDG 801 DOWNTOWN (DD)	Drawn/Checked RDW	DRAWING NO. P-102 Dwg. 50 of 143	

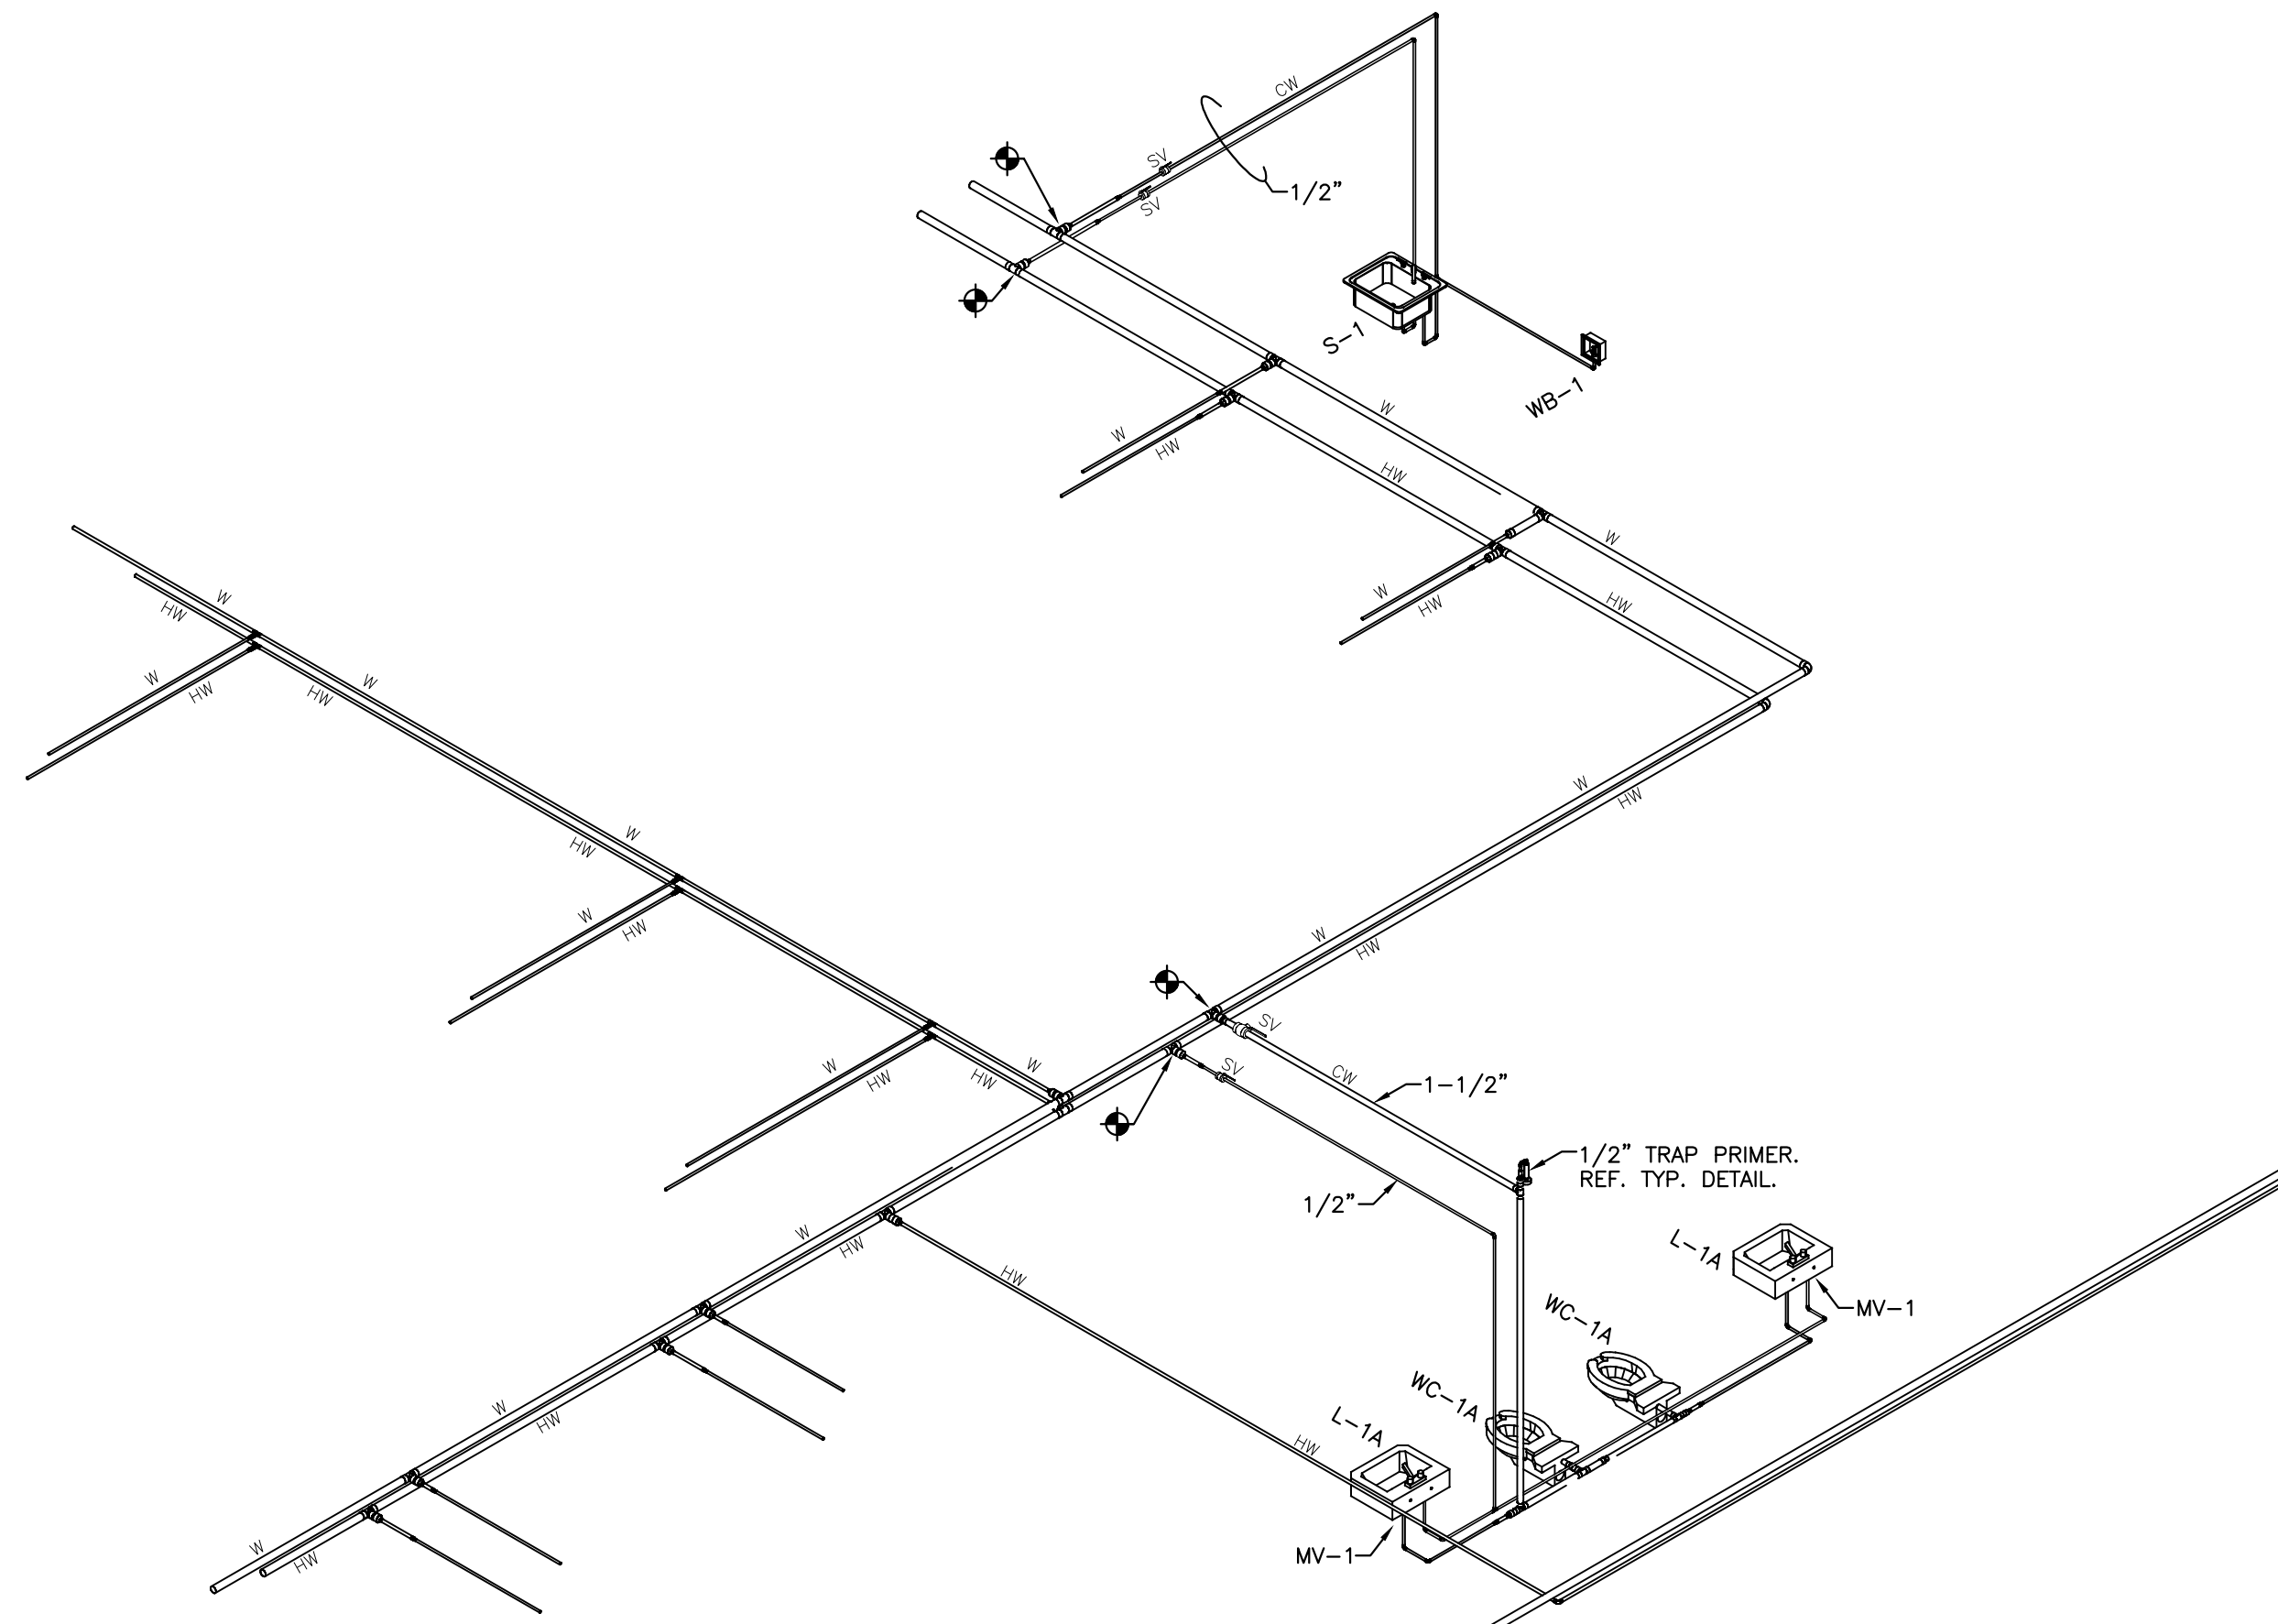
Department of Veterans Affairs

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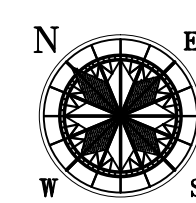
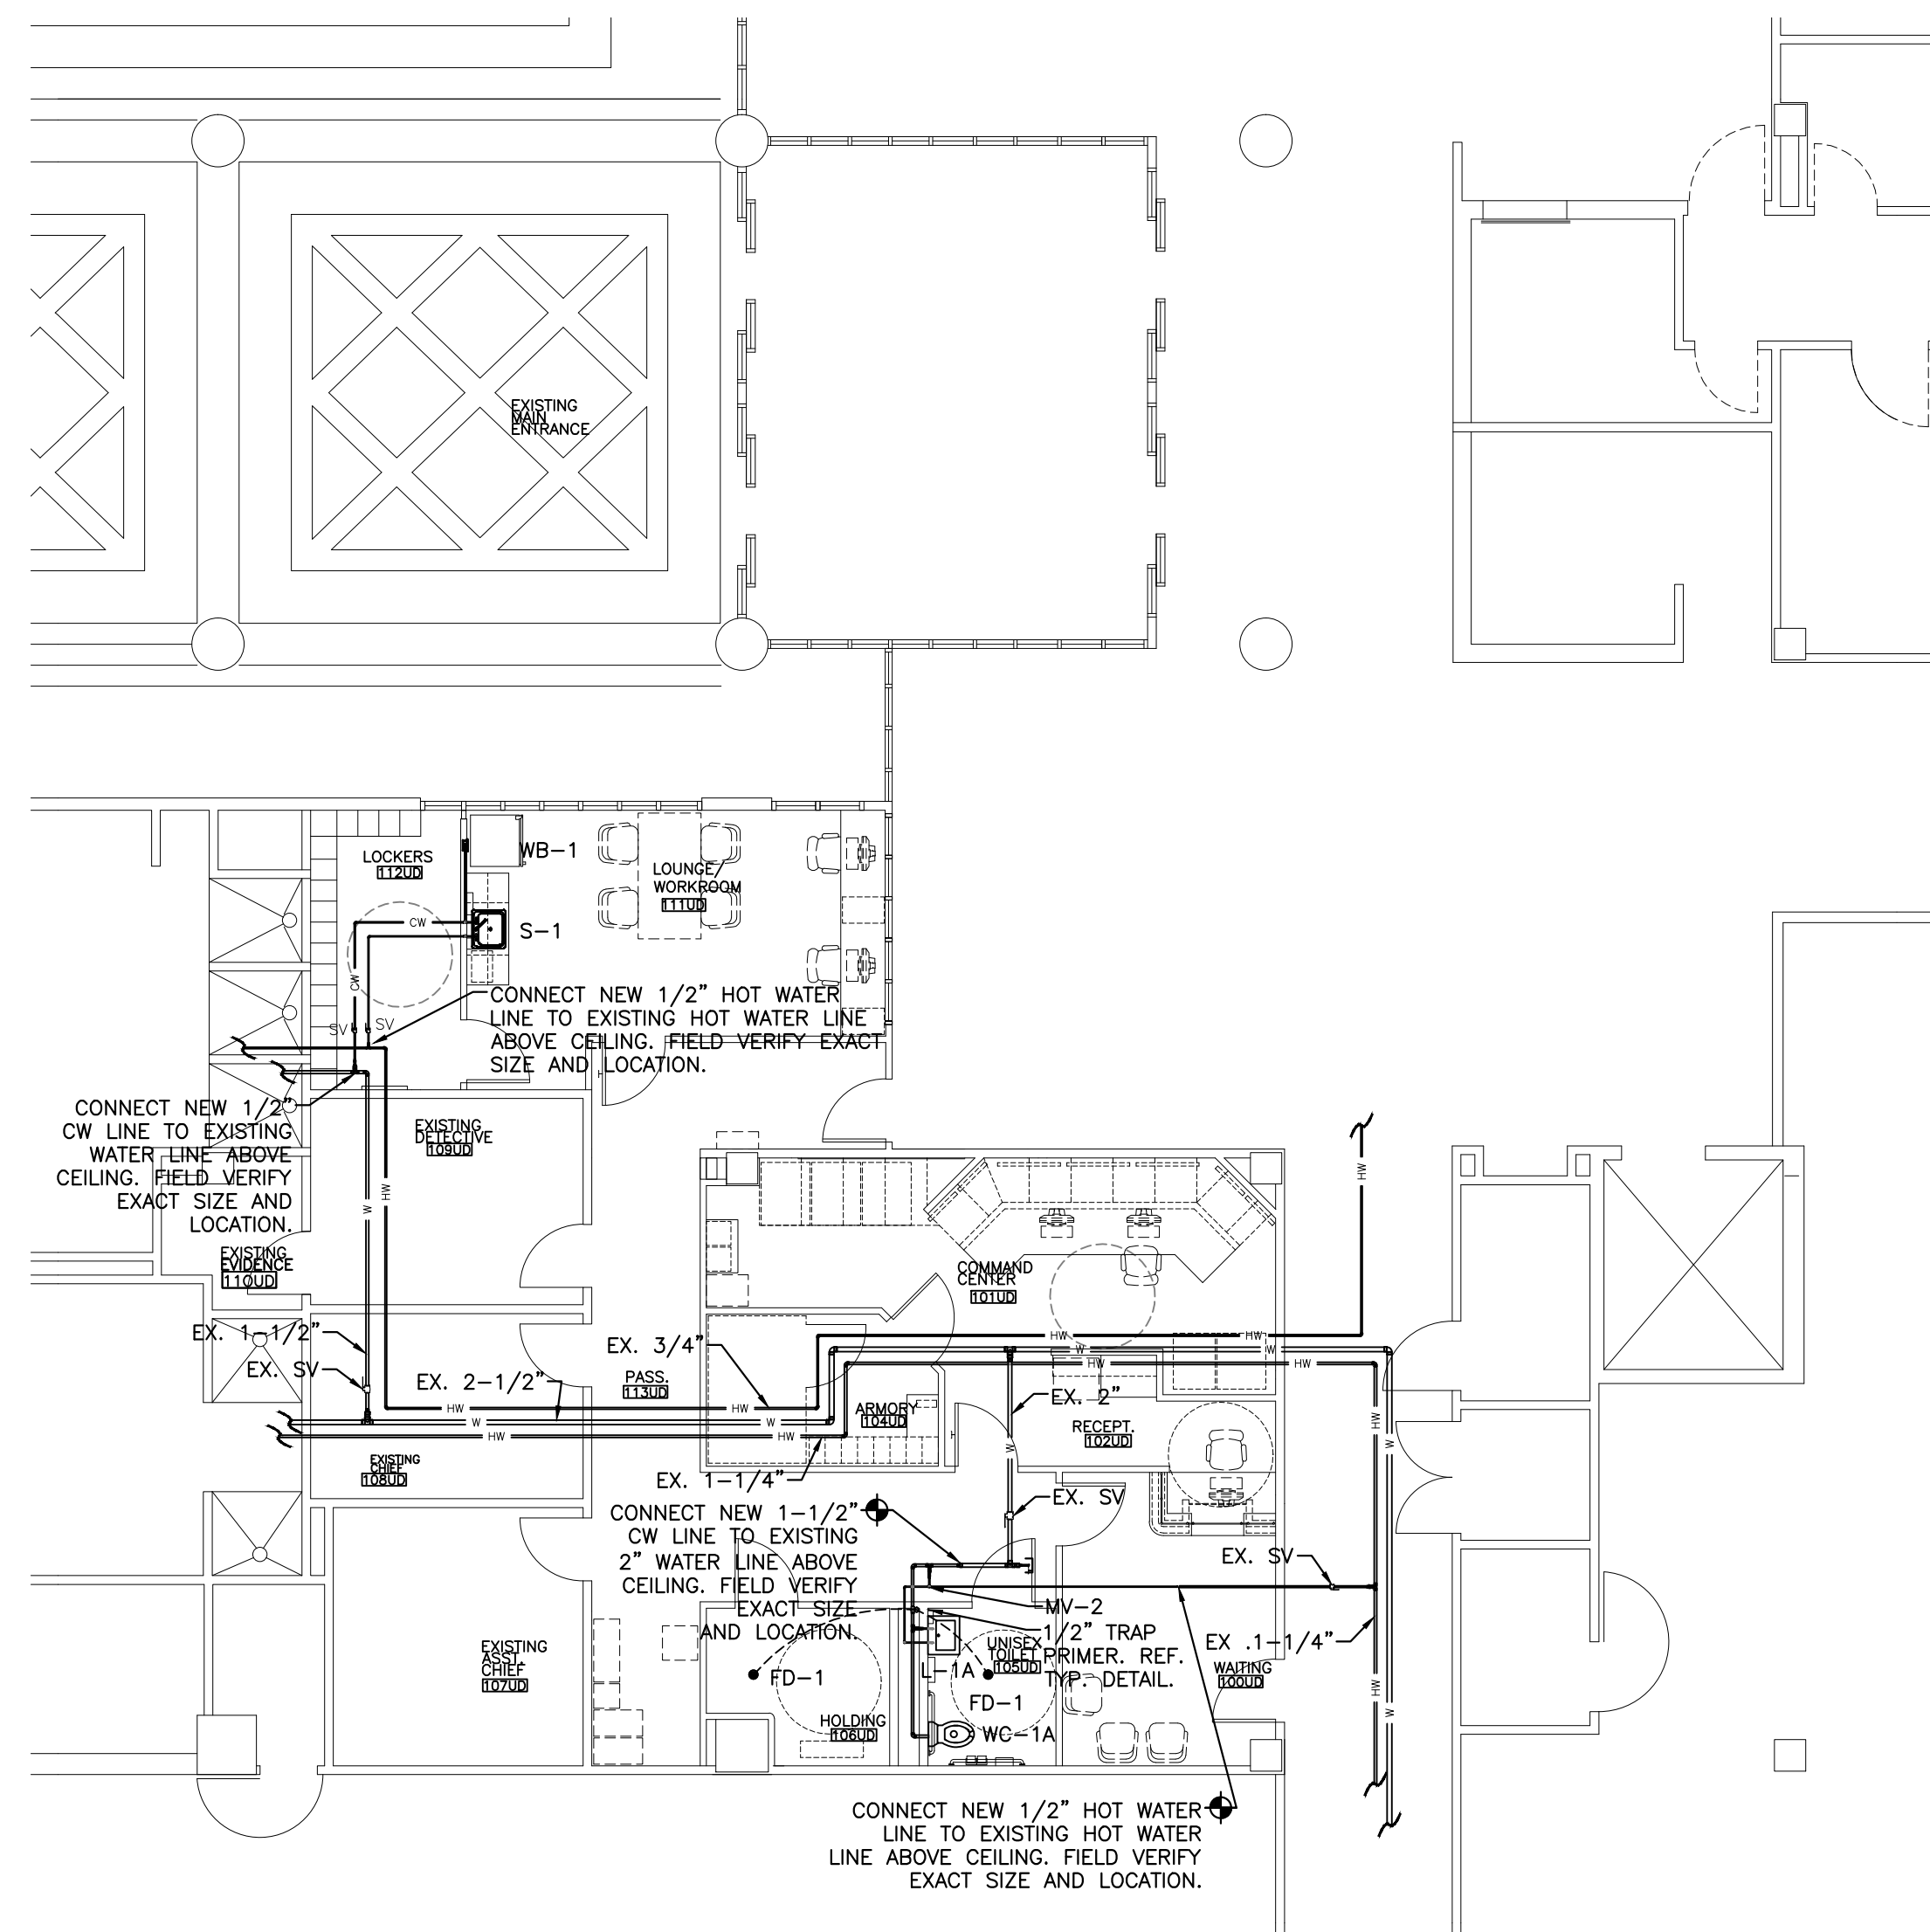
BLDG 801 DOWNTOWN - WATER PLUMBING PLAN

SCALE: 1/8"=1'-0"



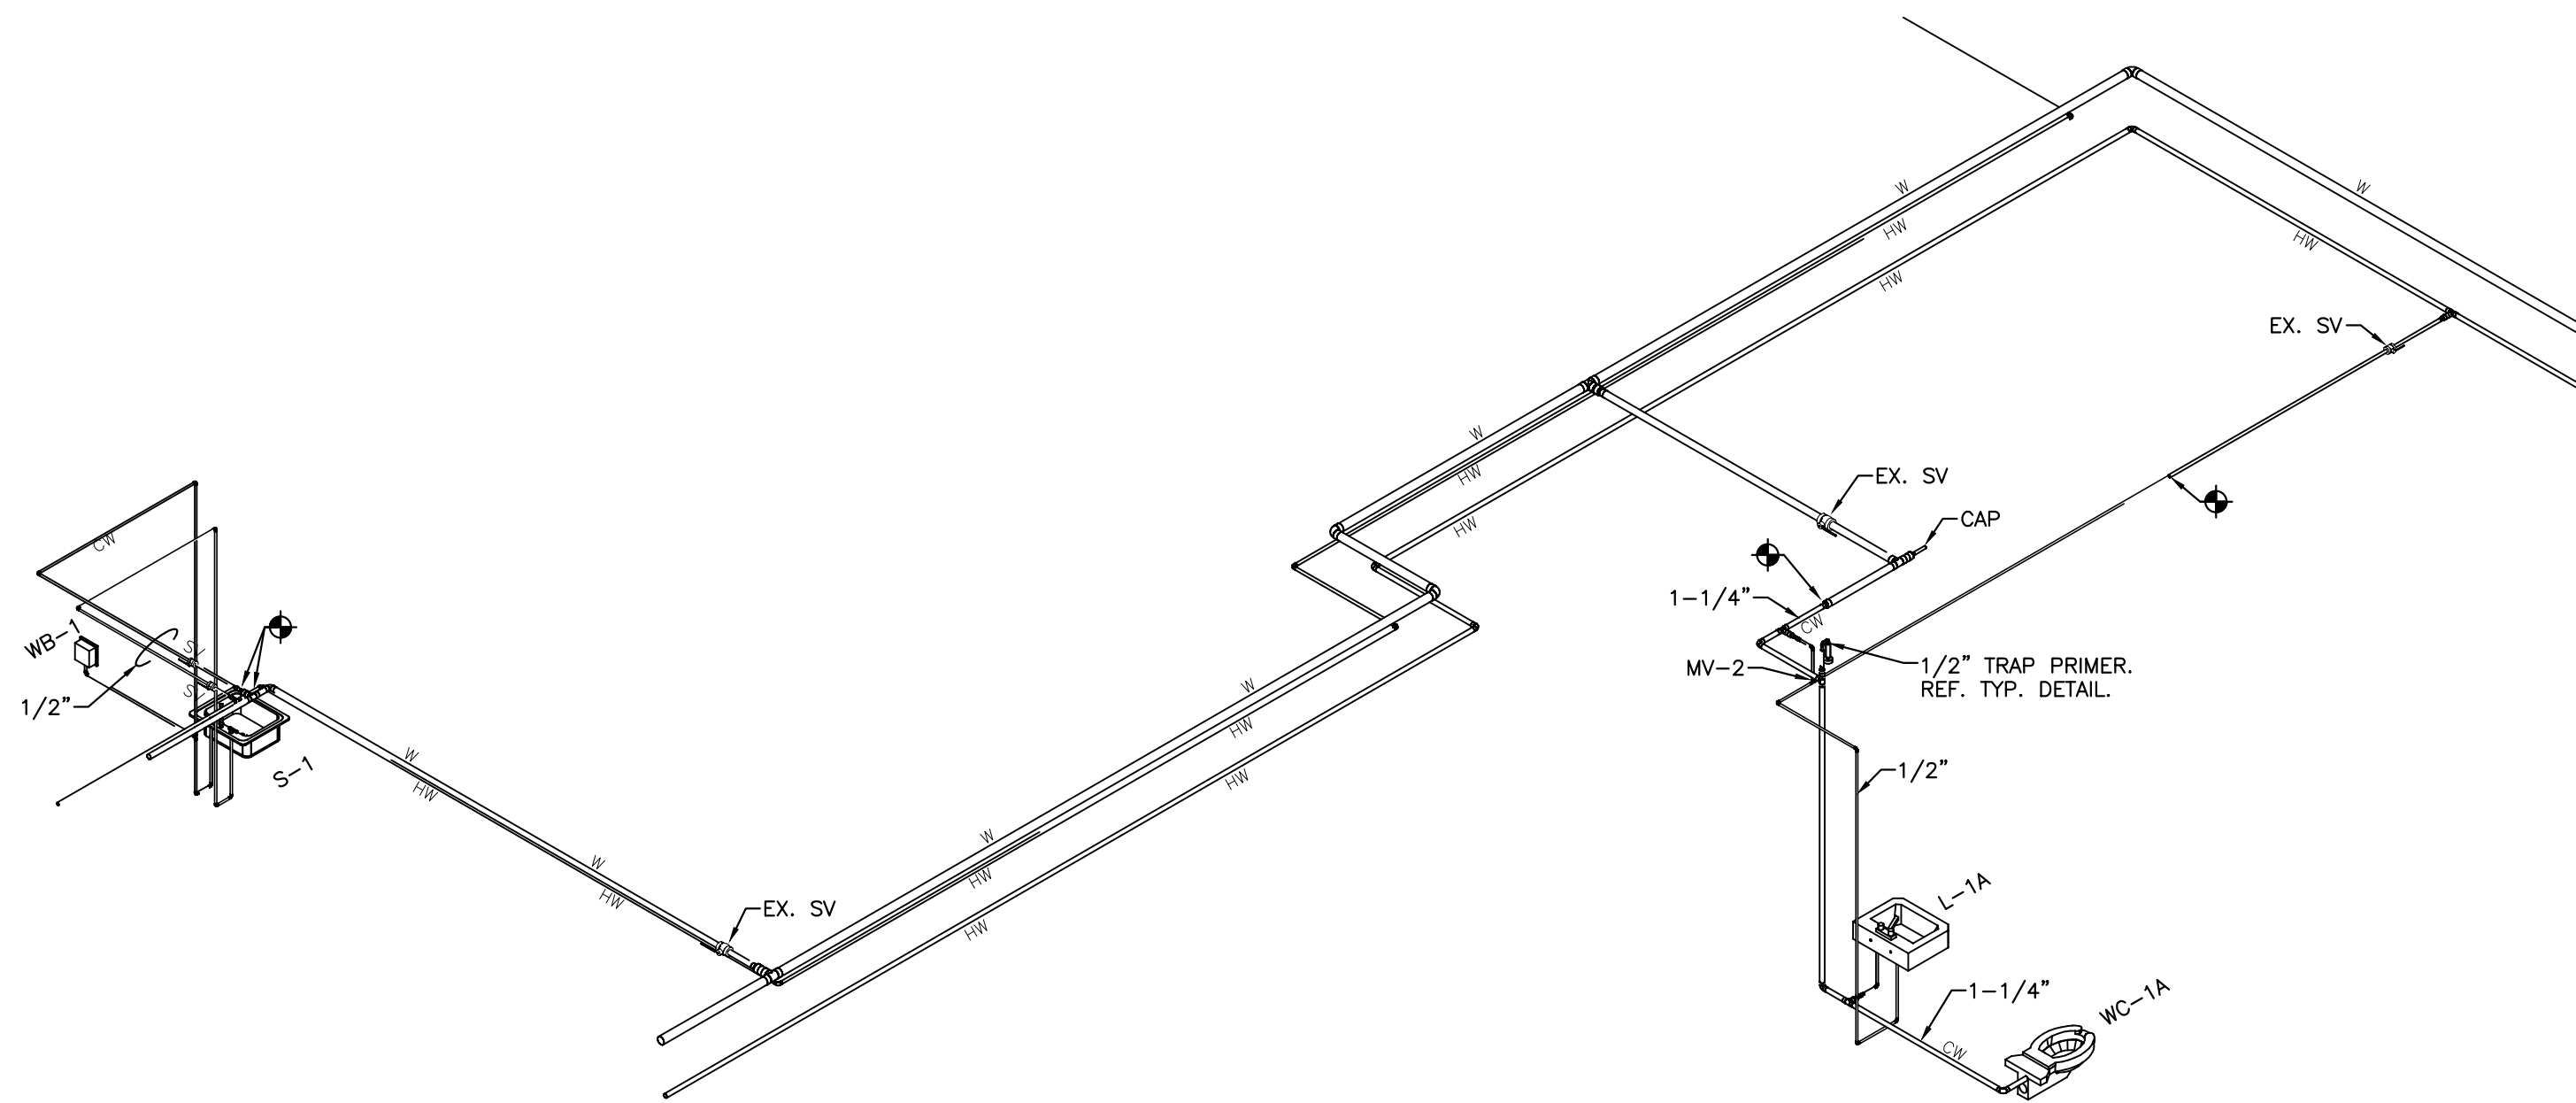
BLDG 801 DOWNTOWN - WATER PLUMBING RISER DIAGRAM

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BLDG 110 UPTOWN - WATER PLUMBING PLAN

SCALE: 1/8"=1'-0"



BLDG 110 UPTOWN - WATER PLUMBING RISER DIAGRAM

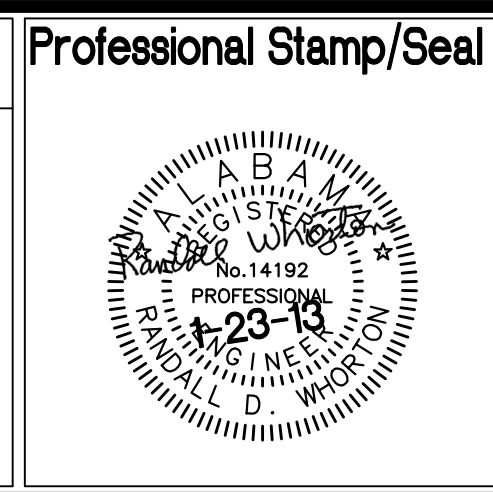
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WATER PLUMBING PLANS

Revisions	Date

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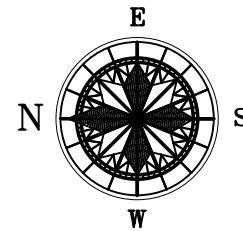
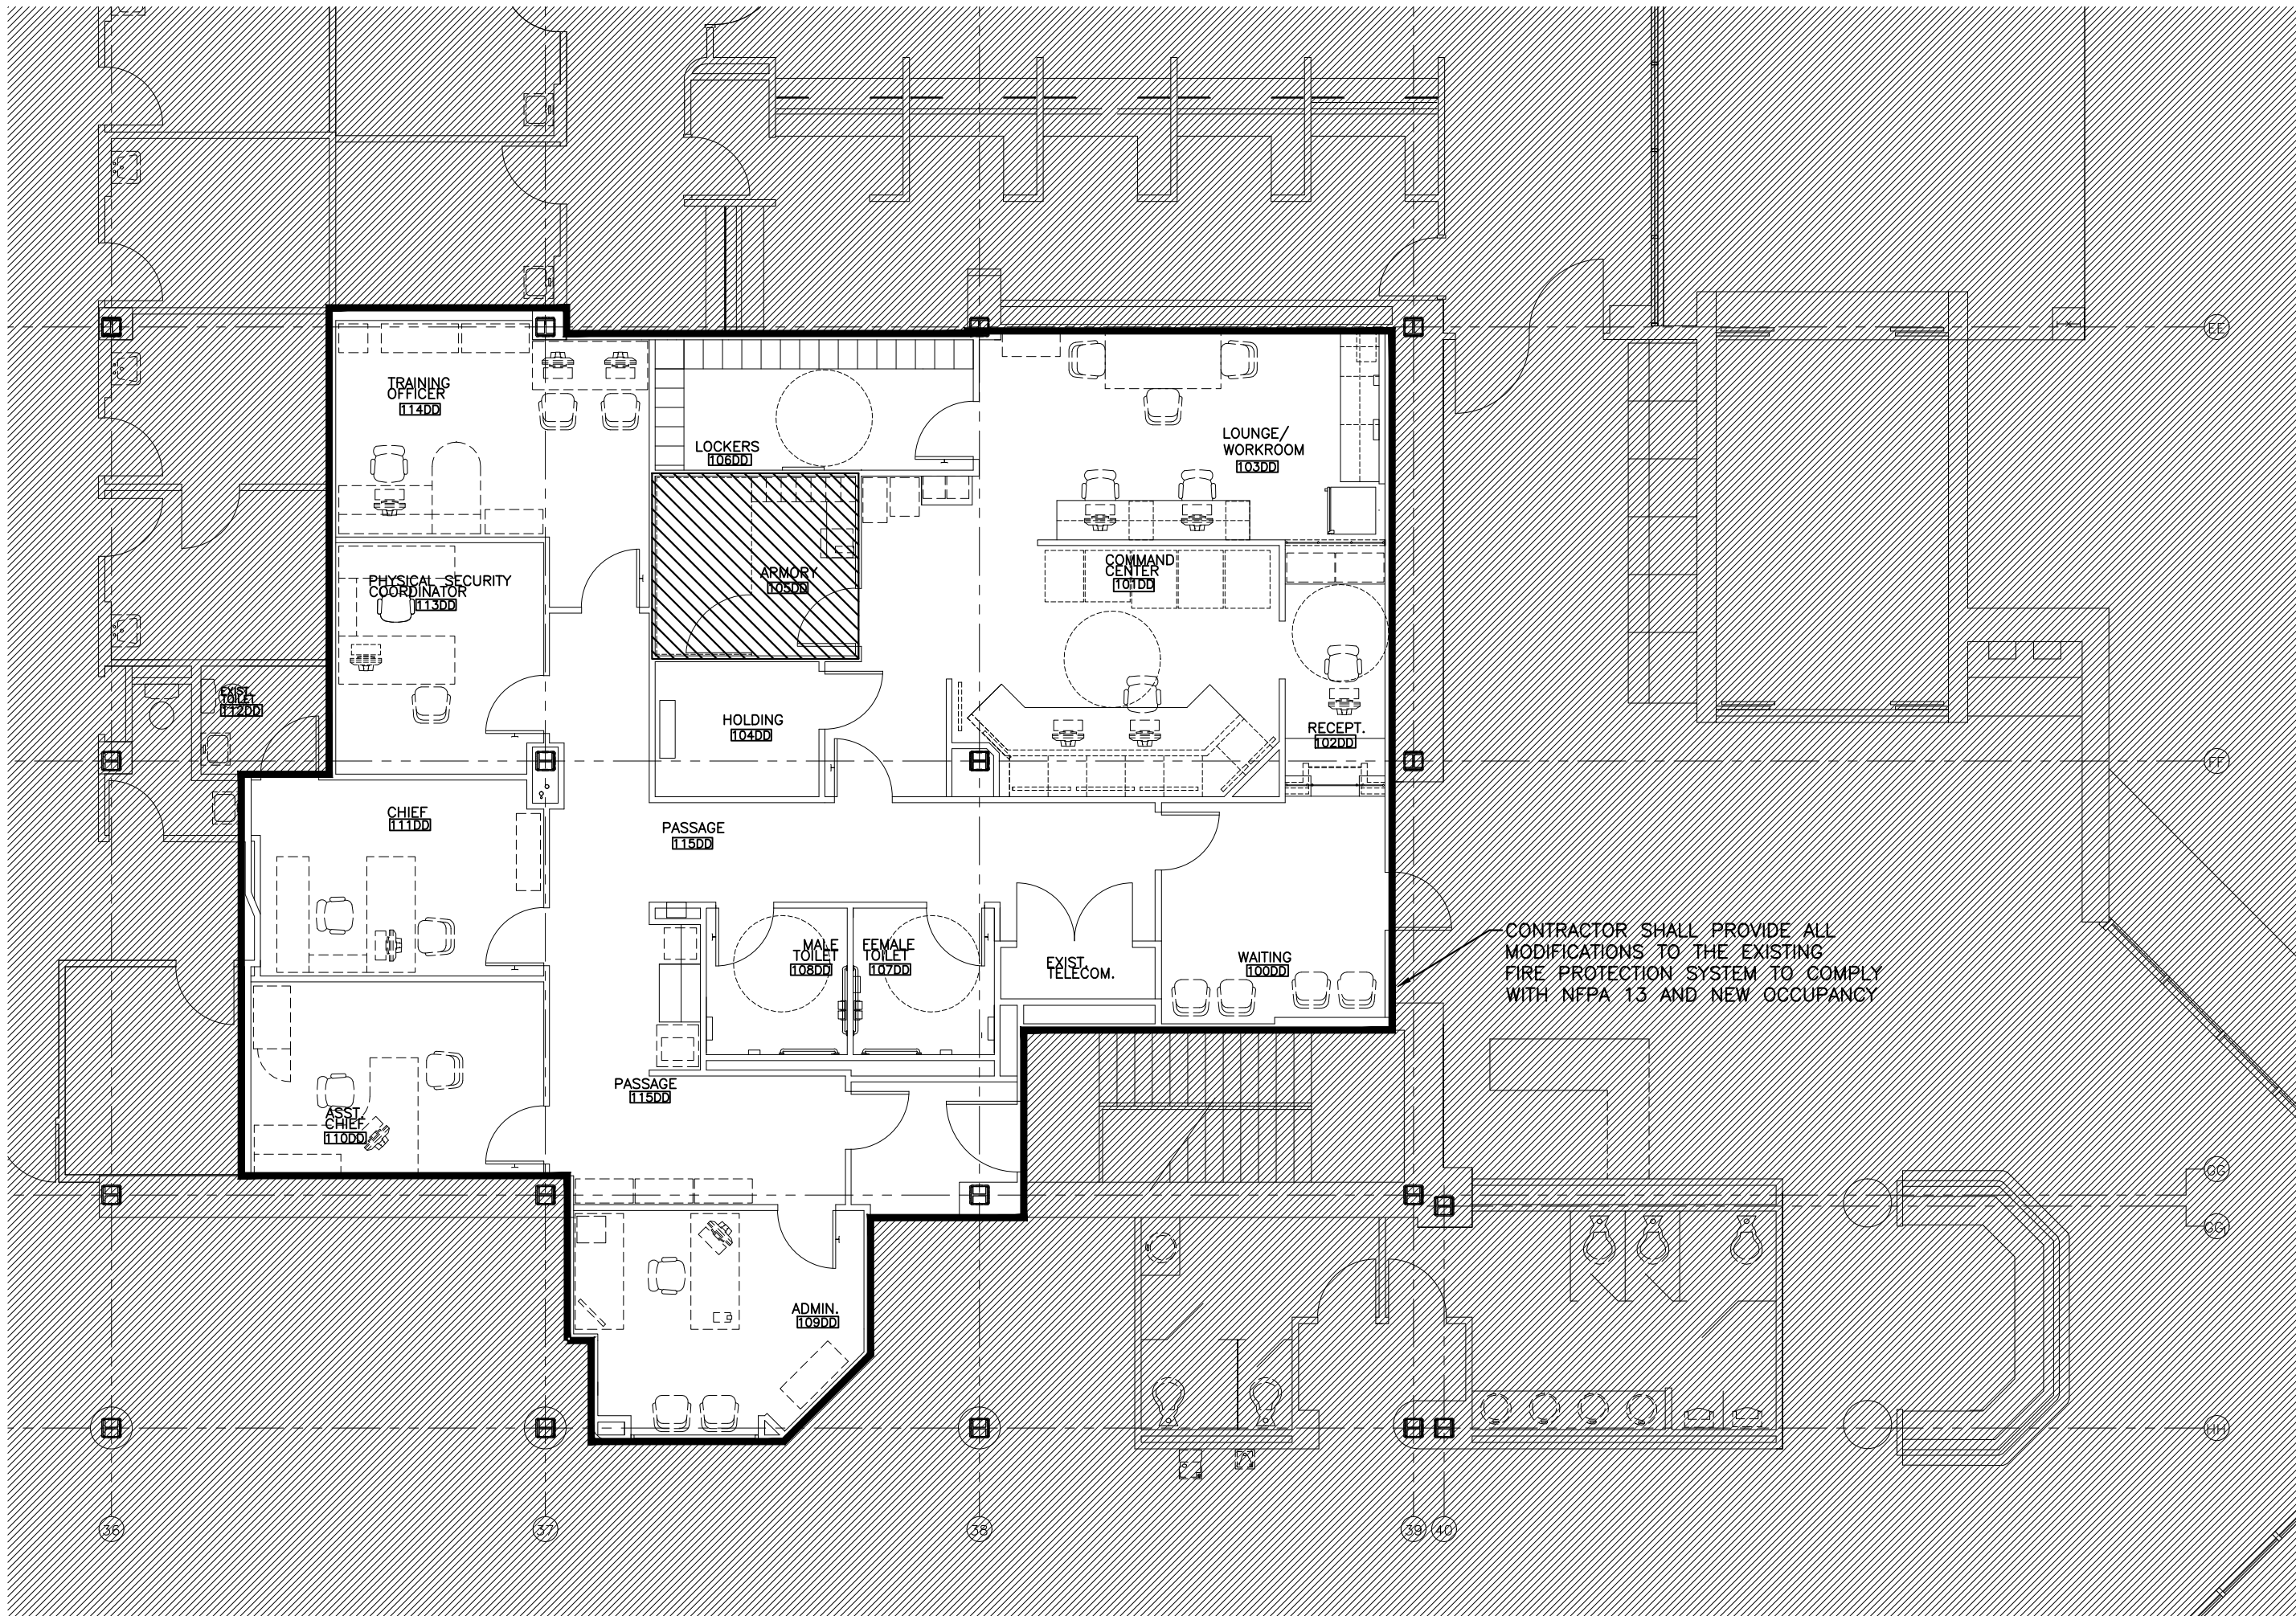
ARCHITECT:
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Drawing Title WATER PLUMBING PLANS		SECURITY ENHANCEMENTS AUGUSTA VAMC, AUGUSTA, GA		Date 01-23-2013 FINAL	Office of Facilities Management
Approved	Approved	Building No. BLDGs 110 +801	Scale 1/8" = 1'-0"	Project No. 509-12-106	
Approved	Approved	Location BLDG 110 UPTOWN (UD) BLDG 801 DOWNTOWN (DD)	Drawn/Checked RDW	DRAWING NO. P-103 Dwg. 51 of 143	
					Department of Veterans Affairs

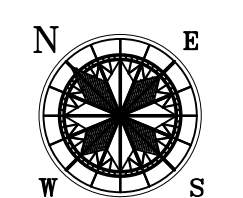
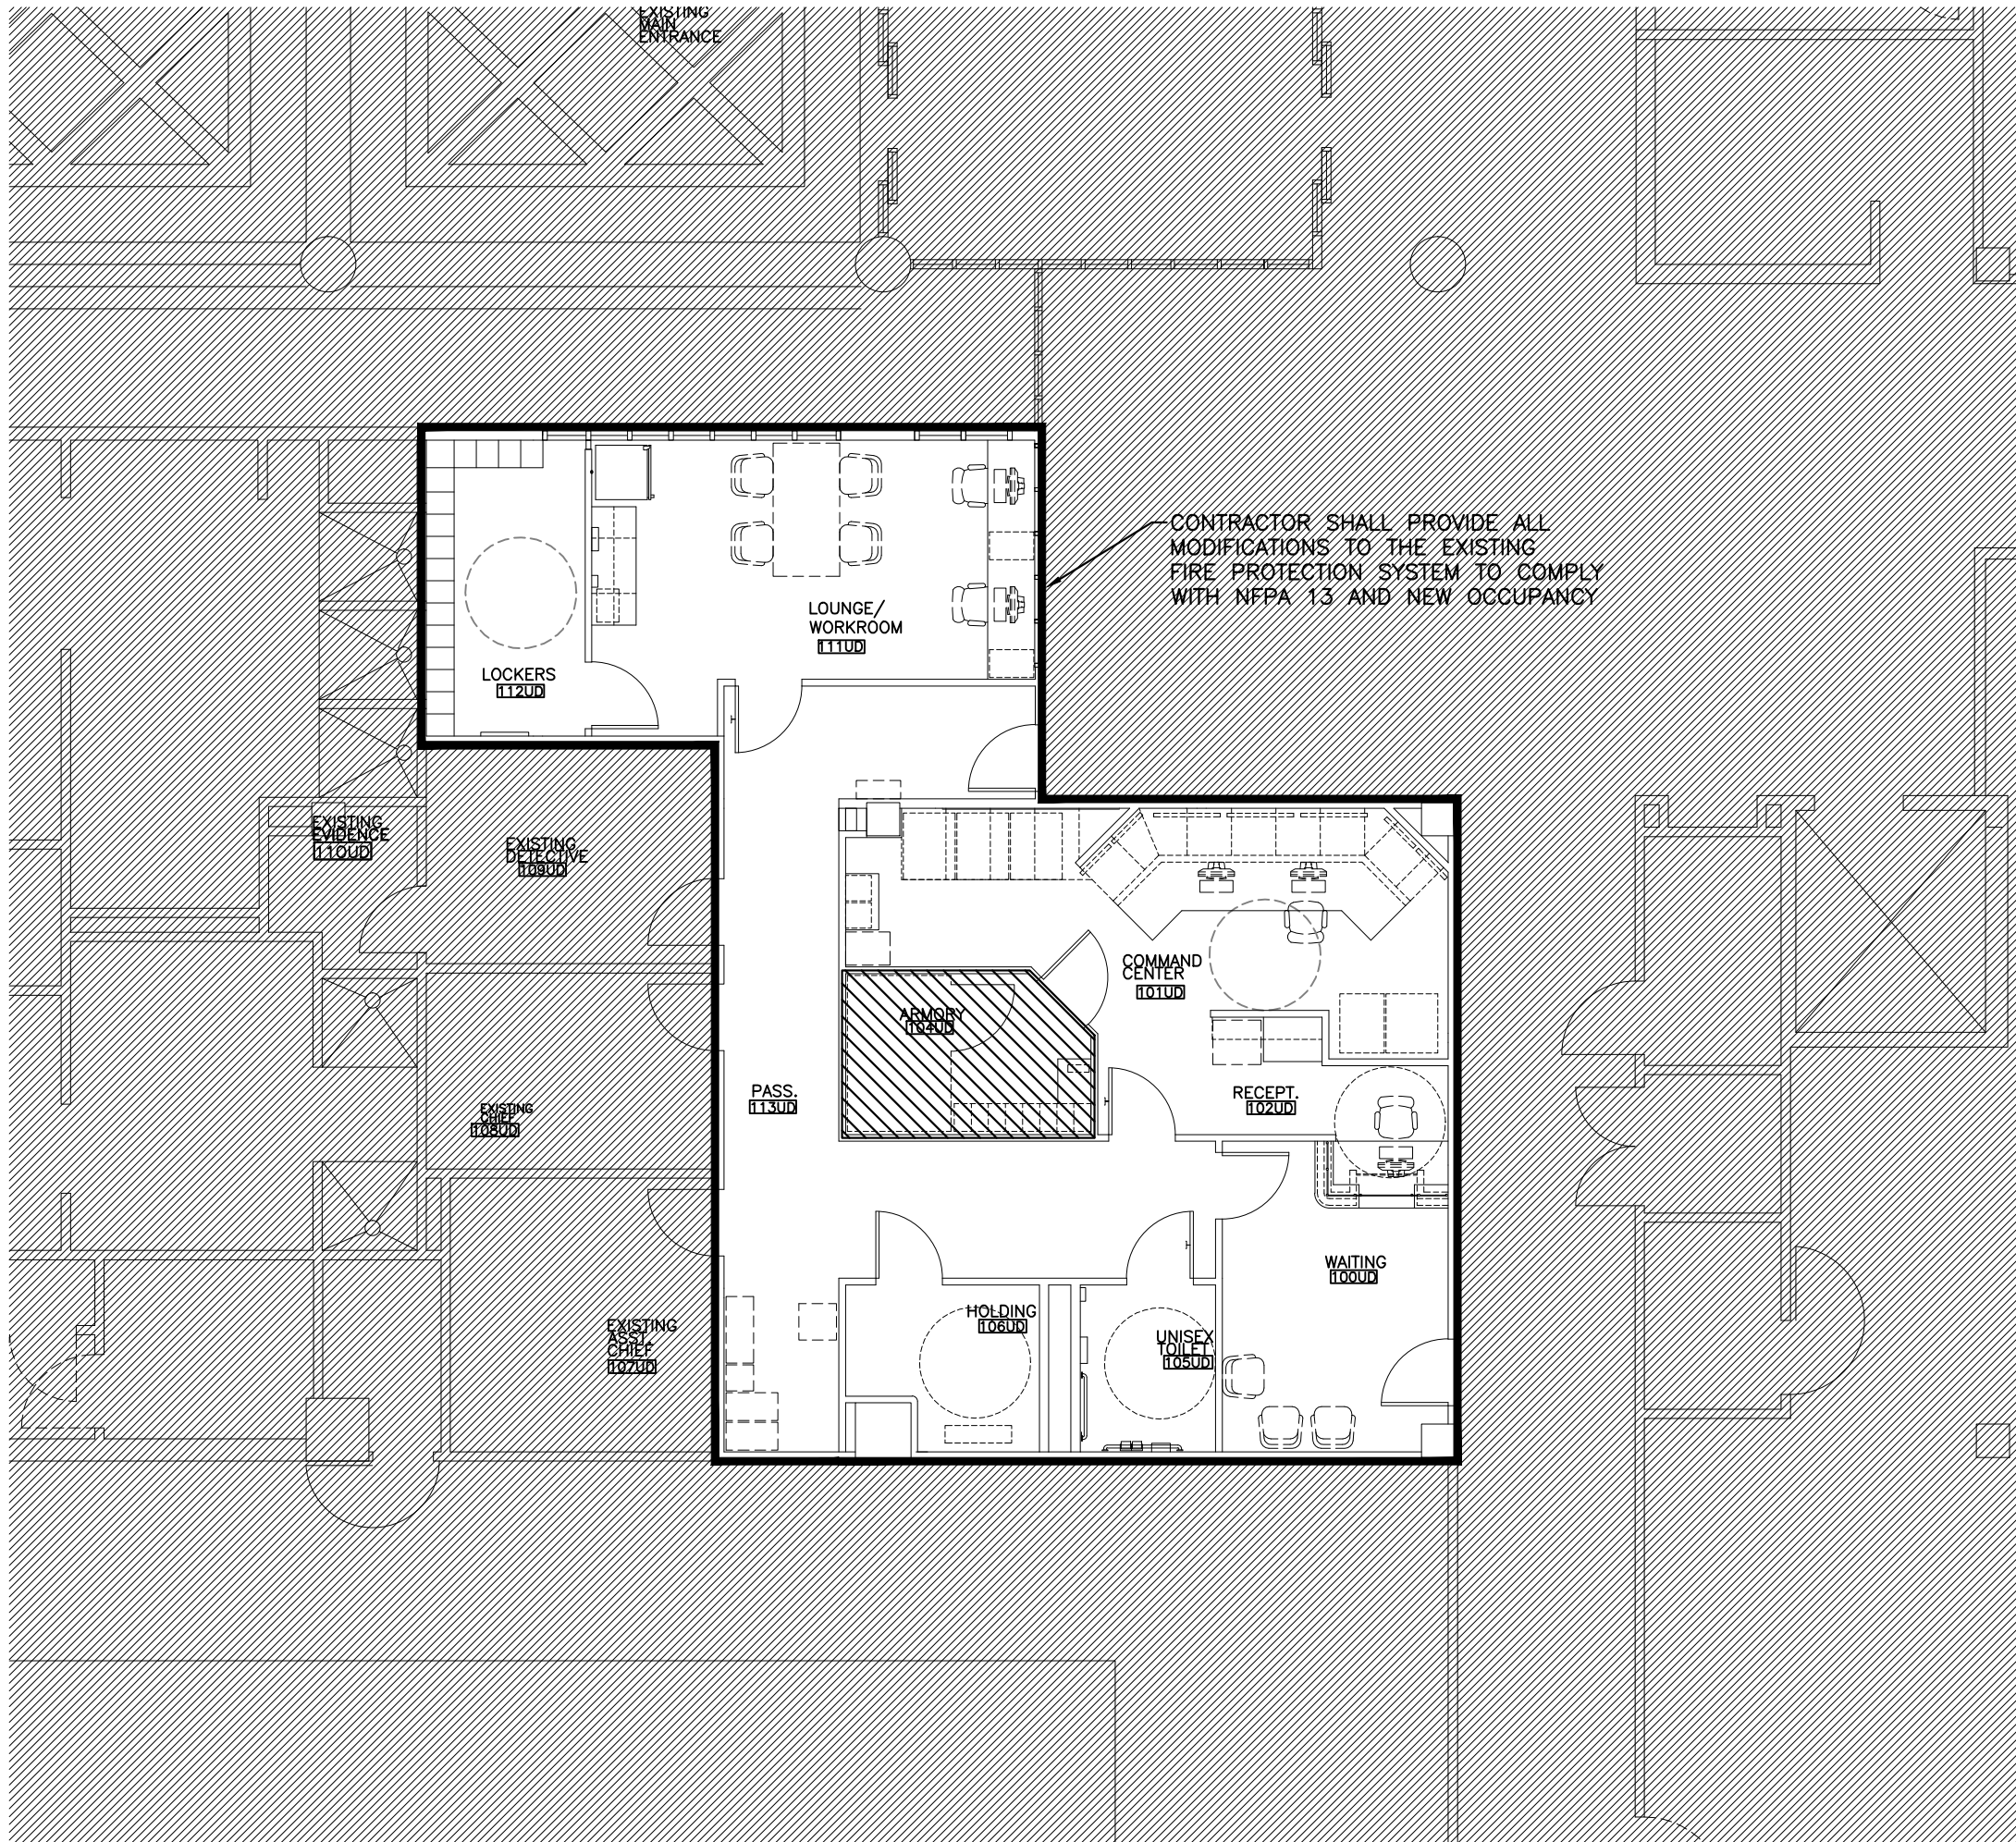
U.S. GOVERNMENT PRINTING OFFICE: 1983-400-285

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BLDG 801 DOWNTOWN - FIRE SPRINKLER PLAN

SCALE: 1/8"=1'-0"



BLDG 110 UPTOWN - FIRE SPRINKLER PLAN

SCALE: 1/8"=1'-0"

FIRE PROTECTION SPECIAL CONSIDERATIONS

SPACE	REQUIREMENT	NOTES
	ORDINARY HAZARD GROUP 1	
	LIGHT HAZARD SPRINKLERS	

FIRE SPRINKLER SYSTEM NOTES

- THE FIRE PROTECTION SYSTEM IS SHOWN IN SCHEMATIC FORM ONLY. THE SUCCESSFUL FIRE PROTECTION VENDOR SHALL LOCATE AND SIZE ALL SPRINKLER HEADS, FIRE DEPARTMENT CONNECTIONS, STANDPIPE SYSTEMS, PIPING, ETC. IN COMPLETE ACCORDANCE WITH NFPA 13 (2010 EDITION) AND THE 2009 INTERNATIONAL BUILDING CODE AND LOCAL REQUIREMENTS.
- SYSTEM DESIGN TO BE IN ACCORDANCE WITH WRITTEN SPECIFICATIONS. ALL HYDRAULIC CALCULATIONS SHALL BE SUBMITTED TO ENGINEER FOR REVIEW AND APPROVAL.
- ALL PIPING SHALL BE INSTALLED IN SUCH A MANNER AS TO AVOID PLUMBING AND HVAC INSTALLATIONS. FAILURE TO COORDINATE WORK WILL RESULT IN REWORK AT CONTRACTOR'S EXPENSE. MAINTAIN MINIMUM STAIR WELL EGRESS CLEARANCE.
- INSTALL ALL ABOVE CEILING PIPING BELOW DUCT.
- INSTALL ALL EXPOSED PIPING AS HIGH AS POSSIBLE.
- ROUTE ALL EXPOSED PIPING IN CHASES WHERE POSSIBLE.
- COORDINATE ALL WORK WITH ARCHITECTURAL, STRUCTURAL, HVAC AND ELECTRICAL TRADES, PLUMBING. PIPE ROUTING SHOWN IS DIAGRAMMATIC. PROVIDE ALL OFFSETS, ETC., TO AVOID INTERFERENCES WITH EQUIPMENT, PIPING, DUCTWORK, LIGHTS, CONDUIT, ETC.
- COORDINATE ALL FLOOR PENETRATIONS WITH STRUCTURAL DRAWINGS. SET SLEEVES IN FLOORS AND WALLS AND ATTACHMENTS FOR HANGERS AS CONSTRUCTION PROGRESSES. ALL PENETRATIONS MUST BE SEALED AND HELD AS TIGHT TO COLUMNS OR WALLS AS POSSIBLE.
- ALL PIPING SHALL BE CONCEALED INSIDE WALLS AND IN PIPE CHASES OR ABOVE CEILINGS. HOLD ALL PIPING ABOVE CEILING AS HIGH AS POSSIBLE.
- ALL STRUCTURAL PENETRATIONS (SLEEVES, BLOCKOUTS, ETC.) ARE TO BE LOCATED AND COORDINATED IN THE FIELD BY THE CONTRACTOR IN RELATION TO THE REQUIREMENTS OF FINAL EQUIPMENT AND FIXTURES SELECTED.
- FIELD VERIFY EXACT SIZE, MATERIAL, AND LOCATION OF ALL EXISTING UTILITIES BEFORE BEGINNING WORK.
- ALL WET PIPING TO BE ROUTED BELOW CEILING INSULATION
- ALL DRY PIPING TO BE ROUTED IN ATTIC SPACE
- THE SCOPE OF WORK FOR THIS PROJECT IS LIMITED TO AREAS SHOWN WHERE THE EXISTING SYSTEM IS MODIFIED AS REQUIRED FOR NEW OCCUPANCY
- ALL FLEXIBLE SPRINKLER HEAD PIPING SHALL BE INSTALLED IN ACCORDANCE WITH MANUFACTURER'S RECOMMENDATIONS AS WELL AS LOCAL, STATE AND FEDERAL CODES/STANDARDS
- ALL NEW SPRINKLER HEADS SHALL BE STANDARD RESPONSE OR QUICK RESPONSE WITHIN THE SAME COMPARTMENT. WHERE EXISTING HEADS ARE REMOVED, THEY SHALL NOT BE RE-USED.

FIRE SPRINKLER INDEX

SHEET NO.	SHEET TITLE
SP-101	FIRE SPRINKLER PLAN

FIRE SPRINKLER PLAN

Revisions	Date

ENGINEERS:

MCE MILLS-CONOLY ENGINEERING, P.C.

8218 Old Federal Road
TELEPHONE: (334) 270-0010

Montgomery, AL 36117
FAX: (334) 270-0040

WHORTON ENGINEERING, INC.

HVAC - PLUMBING - PROCESS CONTROL

25 SUMMERALL GATE ROAD
PH 256/820-9897

ANNISTON, ALABAMA 36205
FAX 256/820-9896

Professional Stamp/Seal

ARCHITECT:

Wesseldyk + Associates

Architecture
Planning
Consulting

1465 Northside Drive N.W.
Suite 215
Atlanta, GA 30318
ph: 404-855-7923



Drawing Title

FIRE SPRINKLER PLAN

Approved

Approved

Approved

Approved

SECURITY ENHANCEMENTS
AUGUSTA VAMC, AUGUSTA, GA

Building No.
BLDGS 110 +801

Scale
1/8" = 1'-0"

Drawn/Checked
RDW

Location
**BLDG 110 UPTOWN (UD)
BLDG 801 DOWNTOWN (DD)**

AUGUSTA, GA

Date
**01-23-2013
FINAL**

Project No.
509-12-106

DRAWING NO.
SP-101

Dwg. 52 of 143

**Office of
Facilities
Management**

**Department of
Veterans Affairs**

RELEASED FOR CONSTRUCTION
100% SPRINKLERED

VA FORM 08-6231, FEB. 1983

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